


### PLANNING COMMISSION AGENDA

MAY 6, 2024 at 7:00 PM

Community Forum at City Hall 17101 W. 87<sup>th</sup> Street Parkway Lenexa, KS 66219

### **AGENDA MAP**

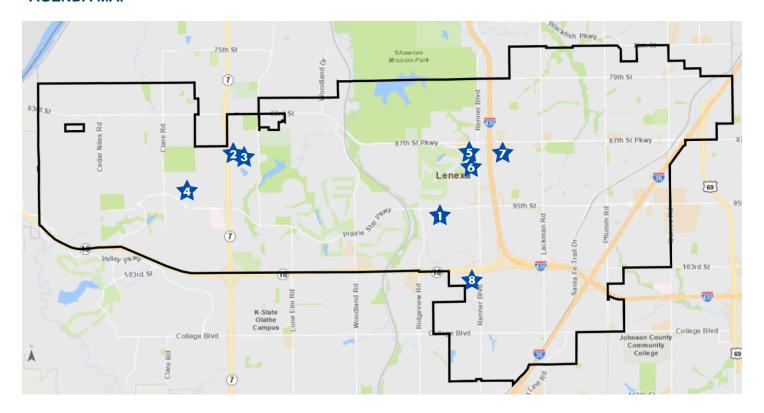

### **CALL TO ORDER**

### **ROLL CALL**

### APPROVE MINUTES FROM THE APRIL 1, 2024 MEETING

### **CONSENT AGENDA**

All matters listed within the consent agenda have been distributed to each member of the Planning Commission for review, are considered to be routine, and will be enacted by one motion with no separate discussion. If a member of the Planning Commission or audience desires separate discussion on an item, that item may be removed from the consent agenda and placed on the regular agenda.

- 1. Central Bank Consideration of a final plan for a new bank located approximately at the southeast corner of Prairie Star Parkway and Ambassador Drive within the PUD, Planned Unit Development District. PL24-06F
- 2. Reserve at Copper Creek Consideration of a final plan and final plat for phase one of a multifamily residential development located approximately at the northwest corner of 89th Street and Woodsonia Drive within the RP-3, Residential Planned (Medium-High Density), RP-



- 4, Residential Planned (High Density), and RP-5, Residential Planned (High-Rise, High Density) Districts. PL24-07F, PT24-06F
- 3. Watercrest Landing Consideration of a final plan to revise private trail amenity plans within the subdivision located approximately at 90th Street between Woodsonia Drive & Monticelllo Road within the RP-1, Residential Planned (Low Density) District. PL24-05FR
- 4. Prairie View at Creekside Woods 4th Plat Revised Final Plat Consideration of a revised final plat to replant three single-family residential lots located at 9341 Carbondale Street within the RP-1, Planned Residential (Low Density) District. PT24-03FR

### **REGULAR AGENDA**

None

### **CONTINUED APPLICATIONS (NO DISCUSSION)**

- 5. City Center Area C Consideration of a preliminary plan for a mixed-use development on property located approximately at the southwest corner of 87th Street Parkway & Scarborough Street within the CC, Planned City Center District. PL24-02P
- 6. AT&T Generator Consideration of a special use permit for a new equipment shelter and generator adjacent to the existing cell tower located at 9100 Renner Boulevard within the CP-O, Planned General Office District. SU24-05
- 7. Sonoma Plaza Phase 3 Apartments Consideration of a revised preliminary plan and final plat for a four-story, multifamily residential development located approximately east of 88th Street & Maurer Road within the PUD, Planned Unit Development District. PL24-01PR, PT24-07F
- 8. Mining/Quarry Reclamation Operation Consideration of a final plan for a mining/quarry operation on an undeveloped site located approximately at the southwest corner of K-10 Highway & Renner Boulevard within the BP-2, Planned Manufacturing and AG, Agricultural Districts. PL24-05F

### STAFF REPORTS

### **ADJOURN**

If you have any questions about this agenda, please contact Stephanie Kisler, Planning Manager, at <a href="mailto:skisler@lenexa.com">skisler@lenexa.com</a>.

If you need any accommodations for the meeting, please contact the City ADA Coordinator at 913-477-7550 at least 48 hours prior to the meeting.

Kansas Relay Service: 800-766-3777

Assistive Listening Devices are available for use in the Community Forum by request.





May 6, 2024


## **CENTRAL BANK**

Project #: PL24-06F Location: Southeast Corner of Prairie Star

Parkway and Ambassador Drive

Applicant: Todd Allenbrand Project Type: Final Plan

Staff Planner: Logan Strasburger Proposed Use: Banking services

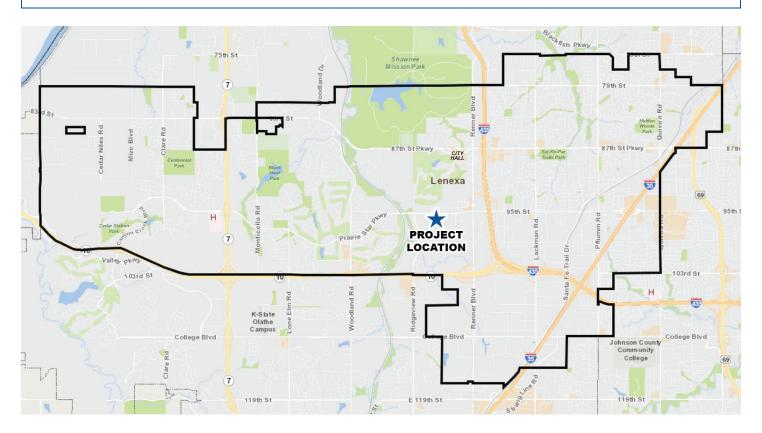

### PROJECT SUMMARY

The applicant proposes to construct a bank within Vista Village development at the southeast corner of Prairie Star Parkway and Ridgeview Road. The structure is one-story tall and totals 4,250 square feet. Vista Village is a Planned Unit Development (PUD) that includes retail, restaurants, multifamily apartments, and townhomes. The proposed final plan is consistent with the approved revised preliminary plan for Vista Village (PL22-02PR), which was approved by the Governing Body on August 29, 2022.

### STAFF RECOMMENDATION: APPROVAL WITH CONDITIONS



### SITE INFORMATION

The site is an undeveloped lot within Vista Village, a Planned Unit Development (PUD) located at the southeast corner of Prairie Star Parkway and Ridgeview Road. Vista Village was initially zoned PUD in 2015 (RZ15-06) with a preliminary plan (PL15-08P). The project has had several revised preliminary plans since the time of rezoning. The most recent revised preliminary plan was approved on August 29, 2022 (PL22-02PR). The subject site is the lot located in the north central portion of the development at the southeast corner of Prairie Star Parkway and Ambassador Drive.

LAND AREA (AC) 1.14 BUILDING AREA (SF) 4,250 CURRENT ZONING PUD COMP. PLAN
Business Park



Exhibit 1: Aerial Image of Subject Site (outlined in red) and the Vista Village PUD (outlined in yellow).



### LAND USE REVIEW

The site is located within Vista Village, a Planned Unit Development (PUD) containing commercial and residential uses. The final plan is for a single-story building for banking services. Per the Comprehensive Plan, the Future Land Use Classification for this area is Business Park. The proposed use is consistent with the zoning designation. The new Comprehensive Plan, which is expected to be adopted soon, will update the Future Land Use Classification of this area to Mixed-Use.

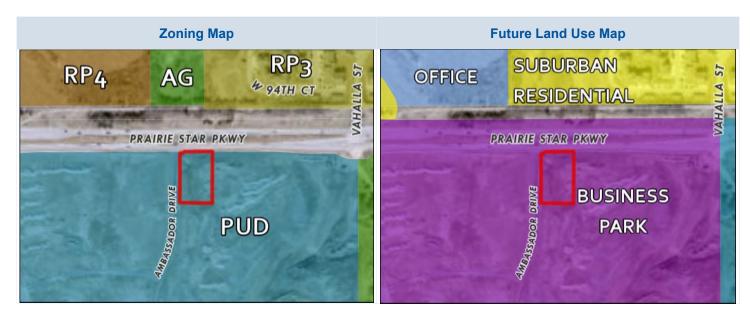



TABLE 1: COMPARISON OF SURROUNDING PROPERTIES					
Vicinity	Land Use Classification	Zoning	Current Use		
Subject Property	Business Park	PUD, Planned Unit Development District	Undeveloped		
North	Office; Suburban Residential	AG, Agricultural District; RP- 3, Residential Planned Medium-High Density District; RP-4, Residential Planned High-Density District	Undeveloped; Multifamily; Agricultural		
South	Business Park	PUD, Planned Unit Development District	Undeveloped		
East	Business Park; Office/Research & Development	PUD, Planned Unit Development District; AG, Agriculture	Undeveloped		
West	Business Park	PUD, Planned Unit Development District	Undeveloped		

The proposed use is compatible with the existing land uses and development on adjacent sites. The preliminary plan for Vista Village shows a series of buildings along the westerly part of the development that faces out to Ridgeview Road. The buildings are anticipated to be retail and restaurants. Between the most westerly buildings and the subject site are to be three apartment buildings featuring a two-level parking deck and various amenities, also known as Alto Apartments. South and east of the subject site are to be townhomes with a clubhouse.



### FINAL PLAN REVIEW

The subject site is centrally located in the most northern part of the Vista Village PUD. The site will front Prairie Star Parkway to the north and Ambassador Drive, a private north-south street within the development, to the west. The site will feature a single-story building, two interactive teller machines (ITMs), and a parking area. The proposed building does not include a traditional drive-thru teller service and lanes attached to the building. Central Bank will be the only tenant of the proposed building.

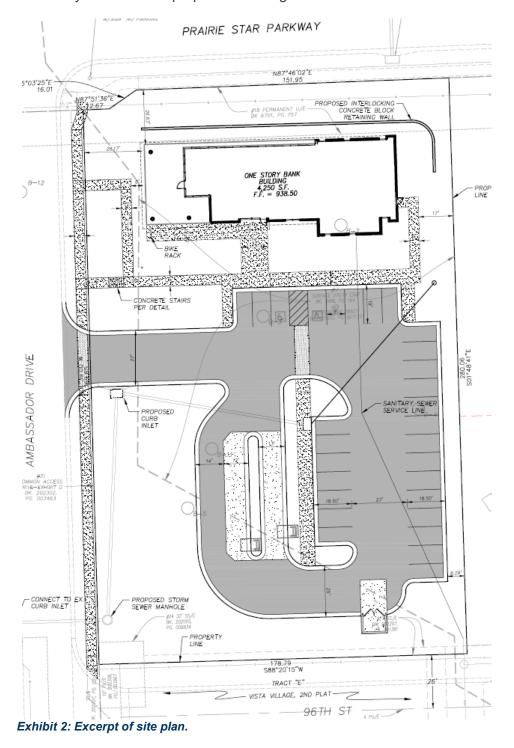



Staff requested that the Construction Over Subsurface Space code, <u>Section 4-1-B-26-C-2</u> be addressed as is required at final plat/plan stage. This was not provided at the time of this report writing. However, understanding that the initial mine study for this property, along with many of the recommendations from that study (such as the mine filling that was completed last year) have been completed, Staff is comfortable moving this application forward with the condition that no permits will be issued until the City has received either a certification that this parcel is in compliance with the previously completed study, or an appropriate study has been submitted, reviewed and approved.

### **PUBLIC IMPROVEMENTS**

No public improvements are required for this project.

### ACCESS, TRAFFIC, AND PARKING


The site features one point of ingress and egress on Ambassador Drive. The internal sidewalk system includes 7' and 5' sidewalks that connect to the public sidewalk system along Ambassador Drive, which in turn links to the sidewalk along Prairie Star Parkway.

TABLE 2: PARKING ANALYSIS					
Туре	Parking Formula	Required Parking	Proposed Parking	Difference	
Vehicle Spaces for Banking services	1 space per 250 SF	17	28	+11	
Bicycle Spaces	1 space per 10,000 SF / 2 space minimum for all uses	2	2	0	

The proposed plans provide an excess of 11 parking spaces from the required 17, as illustrated in <u>Table 2</u>, per the UDC. One bicycle rack with a minimum of two spaces is required per the bicycle parking requirement in <u>Section 4-1-D-1-R</u> of the UDC. The bicycle rack is proposed near the front entrance of the building.

Staff has identified concerns with the Truck Maneuvering Plan (SU-30), a plan which is required to demonstrate how a 30-foot single-unit truck can navigate the site. Additionally, it serves to establish site dimensions for parking and accessibility of various vehicular and pedestrian users. Generally, it is recommended to "accommodate" rather than "design for" such vehicles, especially when they are not the primary users of a site. It is acknowledged that the applicant attempted to accommodate the truck rather than specifically designing for it.



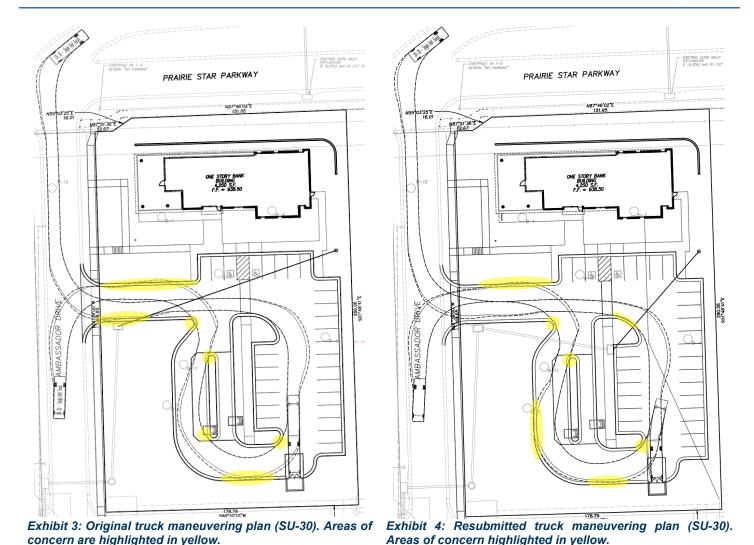

In the original truck maneuvering plan, as illustrated in Exhibit 3, the truck is depicted running over curbs throughout the site and clipping the canopy of the western ITM machine, despite the inclusion of a bypass lane. To address Staff's concerns, the applicant was advised to consider reducing the number of parking spaces (which exceed the code-required amount by 11) to allocate more space for improving curb radii and overall site dimensions, thus enhancing maneuverability, and minimizing the risk of damage to the ITM canopy, landscaping, and curb integrity.

Revised plans, as illustrated in Exhibit 4, show evidence of the applicant's efforts to better accommodate a 30-foot truck by adding clearance for the ITM canopy. However, there is still insufficient curb clearance, resulting in the truck running over curbs throughout the site. Furthermore, in addition to the outstanding issues with truck maneuverability, Staff did not receive requested information regarding the internal traffic circulation.

As of the writing of this report, Staff has not received updated plans addressing these concerns. Staff requests that the applicant continue to work with Staff to address outstanding issues relating to the SU-30 plan and traffic circulation before the issuance of a building permit as a condition of approval for this project.



### STORMWATER

Stormwater management was completed for the overall development site, of which this parcel is a part of. The stormwater management for this specific parcel has already been constructed, thus this parcel satisfies the City's requirements.

### **FIRE**

The Fire Department reviewed the plans based on the current adopted fire codes and local amendments. All general planning review comments have been acknowledged or satisfied and there are no outstanding Fire Department planning review items that need to be addressed for this project to move forward. A more detailed fire code review will be conducted based on the adopted codes at the time of the building permit documentation submittal.

### LIGHTING

The proposed photometric plan and lighting is consistent with the Vista Village design guidelines and the UDC.

### LANDSCAPING

The proposed landscaping for the site aligns with the landscape criteria outlined in both the Vista Village Design Guidelines and Section 4-1-D-2 of the UDC. Along Prairie Star Parkway and Ambassador Drive, perimeter landscaping will feature a mix of trees and shrubs. Additionally, the parking lot landscaping plan encompasses a diverse array of trees and shrubs strategically positioned to provide both visual screening for vehicles from future residential properties to the west and east and shade for impermeable surfaces and cars, thereby minimizing their environmental impact.

The site entrance will be enhanced through the incorporation of lushly landscaped curbs adorned with a variety of flowering plants, shrubbery, and a centrally positioned tree on the north curb.

The trash enclosure situated near the southeastern corner of the parking area will be discreetly screened with shrubs and surrounded by trees.

Pedestrian crosswalks will be of decorative contrasting pavement as required by the Vista Village Design Guidelines and the UDC. Pedestrian-oriented amenities for the site include tables, chairs, and benches on the west portion of the building under the columns (Exhibit 6).

### **ARCHITECTURE**

The building is one-story and totals 4,250 SF. The entrance to the building features aluminum composite elements in the canopy, columns, and

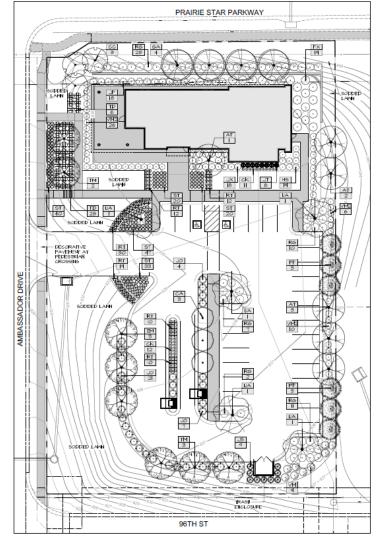


Exhibit 5: Excerpt of landscape plan.

façade above and to the west of the entrance (Exhibit 9). One third of the building is wrapped in manganese



colored brick with darker brick band accents on the lower, middle, and upper portion of the building to create contrast and depth. The remaining two thirds of the building is wrapped in aluminum composite panels and curtain wall windows (Exhibit 7 & 8). The trash enclosure located at the southeast corner of the site will be constructed of like-masonry materials with a composite wood gate in a steel frame.



Exhibit 6: Rendering of northwest side of the building with ITM's pictured in the foreground.




Exhibit 7: Rendering of northeast side of the building with trash enclosure and parking lot in the foreground.



Exhibit 8: Rendering of northwest side of the building.



Exhibit 9: Rendering of the southeast side of the building.

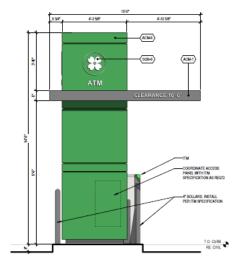


The proposed ITM (Exhibit 10, at left) feature green aluminum composite panels and display the Central Bank dogwood flower logo on their north, east, and south facades. On the west elevation, a white dogwood flower pattern stands out in contrast to the green panel. Directional signage is displayed on the north and south faces of the attached aluminum canopy. It is Staff's opinion that these design choices do not adequately integrate the main architectural style of the site into the ITM, thus not aligning with the Vista Village Guidelines and UDC. Staff recommends that the applicant continue to work with Staff to revise the architectural elements of the ITM machines before a building permit is issued, as a condition of plan approval.

At left: Exhibit 10: Proposed ITM.



Proposed architectural materials and elements incorporated into the building must adhere to the Vista Village Design Guidelines. Upon review, it was determined that the proposed materials and elements did not align with the established guidelines, necessitating approval from the developer. Subsequently, the developer provided written approval for the proposed materials, citing the materials' compatibility with future development and ability to harmonize with the overall design vision of Vista Village.

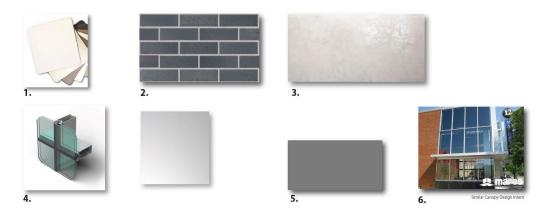

Signs on the building and ITMs will require separate reviews and permits. Signs depicted on elevations and renderings are for illustrative purposes only and are not considered within the scope of the final plan. A total of four facade signs are proposed on the building, surpassing the maximum of three allowed per Section 4-1-E-11-C of the UDC for a single-tenant building. Consequently, a sign deviation request will be required for the installation of a fourth sign. The applicant has opted to pursue a sign deviation request separately from this final plan application.

### **DEVIATIONS**

The applicant is not requesting any deviations from the Unified Development Code (UDC). It should be noted that if there is a desire to add a fourth façade sign to the building, a sign deviation request is required per the UDC.

### **NEXT STEPS**

- The Planning Commission is the final authority for approval of this project.
- The applicant must work with Staff to address outstanding issues as noted in the Staff recommendation.
- The applicant must receive permit(s) prior to commencing construction.
- The applicant must obtain a Certificate of Occupancy before opening for business.
- The applicant must obtain a Business License prior to opening for business.

### RECOMMENDATION FROM PROFESSIONAL STAFF

### **★** Staff recommends approval of the proposed Final Plan for Central Bank.

- This is a final plan for development of a bank.
- The project is consistent with Lenexa's goals through **Responsible Economic Development** to create **Inviting Places** and a **Thriving Economy.**
- The applicant intends to submit a sign deviation application separate from this application.



### FINAL PLAN

Staff recommends **approval** of the final plan for PL24-06F – **Central Bank** at the southeast corner of the intersection of Prairie Star Parkway and Ambassador Drive, for a bank with the following conditions:

- 1. Prior to the issuance of any development or building permits, the applicant shall work with staff to address the following:
  - i. Resolve issues concerning internal traffic circulation as indicated on the truck maneuvering plan (SU-30 turning template).
  - ii. Revise the elevations and plans of the ITM machines to better harmonize with the architectural style of the bank, ensuring seamless integration with the overall development, as outlined in the Vista Village Design Guidelines and the UDC.
  - iii. Provide certification demonstrating compliance with a previously conducted mine study for this parcel or submit an appropriate mine study for review and approval.



Data Source: City of Lenexa and Johnson County Kansa

# Central Bank PL24-06F







SIDEWALKS SHALL BE CONCRETE. PRIVATE DRIVES SHOWN HEREON WILL PROVIDE

AND AMBASSADOR DRIVE.

- SHARED ACCESS FOR EACH LOT WITHIN THE
- 3. STORMWATER DETENTION IS PROVIDED BY EXISTING DETENTION BASINS WEST OF RIDGEVIEW ROAD AND AT THE NORTHEAST CORNER OF 98TH
- 4. WATER QUALITY TREATMENT IS PROVIDED BY A COMBINATION OF EXISTING FACILITIES AND VIA NATIVE VEGETATION AS SHOWN ON THE LANDSCAPE PLAN.

VICINITY ZONING PATTERN. NORTH: AG, AGRICULTURAL, NPO, PLANNED NEIGHBORHOOD OFFICE & RP-3, PLANNED RESIDENTIAL MEDIUM HIGH DENSITY ZONING DISTRICTS SOUTH: BP-2, PLANNED MANUFACTURING ZONING

EAST: PUD. PLANNED UNIT ZONING DISTRICT WEST: AG. AGRICULTURAL ZONING DISTRICT (PARK)

### LEGAL DESCRIPTION:

LEGAL DESCRIPTION:

LOT 9, WSTA MILIAGE 1ST PLAT, A SUBDIVISION IN
THE CITY OF LENEXA, JOHNSON COUNTY, KANSAS,
EXCEPT THAT PART LYING BELOW THE FARLEY LEDGE
OF LIMESTONE (UNDERGROUND TRACT) AS CONVEYED
IN QUIT CLAIM DEED BOOK 201203-007133.

### LEGEND:

DISTRICT

LIGHTPOLE VA 1-4

EXISTING CURB INLET TOP=945.84 £ OUT(N) 941.70 (15" CMP)

18.50"

- PROPERTY LINE




DENOTES CONCRETE SIDEWALK



DENOTES CONCRETE PAVEMENT



DENOTES ASPHALT PAVEMENT

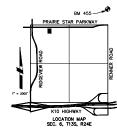



Payne & Brockway, P.A.

CIVIL ENGINEERS & LAND SURVEYORS






# enex **New Facility** Bank, Central

Parkway and Amba: Lenexa, KS 66219

Revisions Revisions:

1 4-19-24 PER CITY COMMENTS 23-0028 Final

> SITE PLAN C100

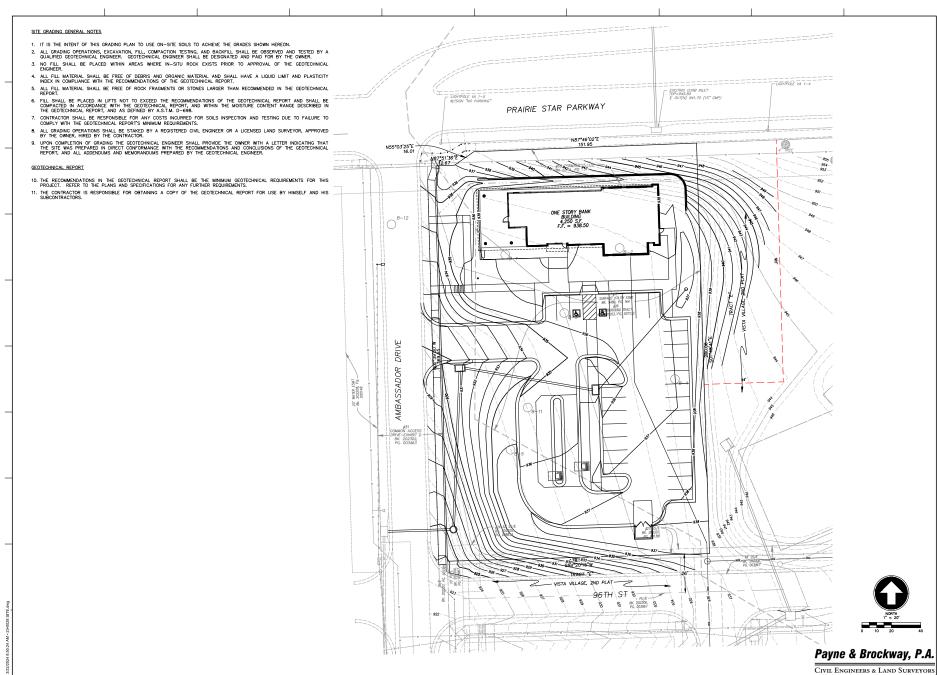







New Facility

Central Bank

Prairie Star Parkway and Ambass

Lenexa, KS 68799


Revisions:

1. 1-19-24 FR DIT COMMENTS

Proped 8: 23-0028

Final Development Plan

C101

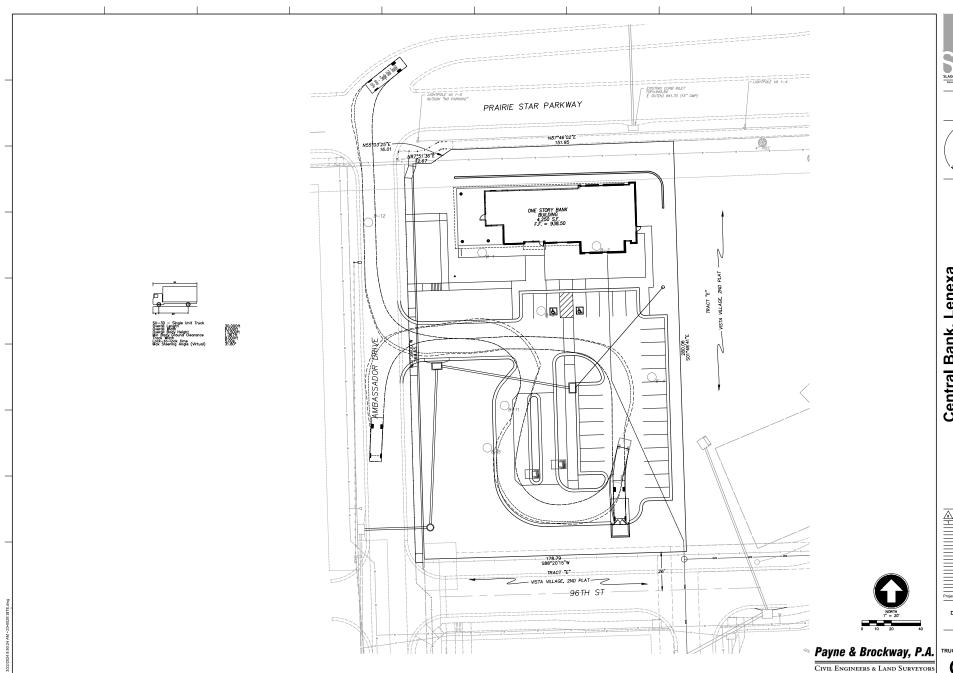








# Central Bank, Lenexa New Facility Central Bank Prolite Stare Parkeay and Ambassador Drive Lenexa, KS 66219

Revisions: 19-24 PER DITY COMMENTS



JCK MANEUVER PLA

C102

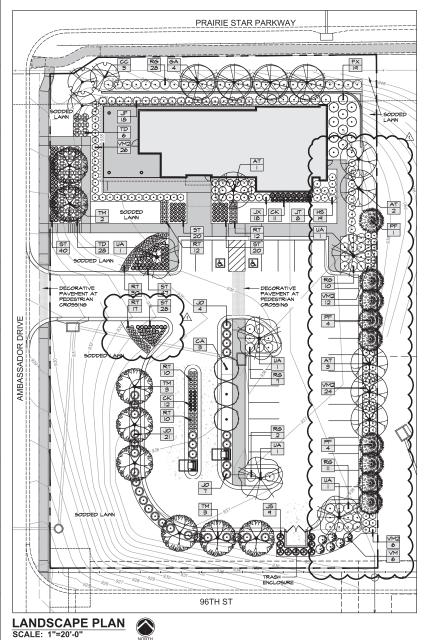

YMBOL	CODE	BOTANICAL NAME	COMMON NAME	SIZE	CONTAINE
REES	JТ	Juniperus virginiana 'Taylor'	Taylor Eastern Redcedar	6' Ht. Min.	B4B
VERGRE	JS	Juniperus scopulorum 'Skyrocket'	Skyrocket Juniper	7'-8' ht.	B4B
(1)	PF	Pinus flexills 'Vanderwolf's Pyramid'	Vanderwolf's Pyramid Limber Pine	7'-8' ht.	B4B
RNAME	NTAL TRE	ES			
( <b>)</b>	cc	Cercis canadensis	Eastern Redaud	2" Cal.	B4B
$\odot$	CA	Cercis canadensis 'Ace of Hearts'	Ace of Hearts Eastern Redoud	2" Cal.	B4B
SHADE TE	AT	Acer truncatum	Shantung Maple	2º Cal.	B#B
$\bigcirc$	бA	Ginkgo biloba "Princeton Sentry"	Autumn Gold Maldenhair Tree	25° Cal.	B4B
$\Theta$	тм	Taxadium distictum 'Mickelson'	Sharnee Brave± Bald Cypress	25' Cal.	B4B
	UA	Ulmus parvitolia 'Allee'	Allee¢ Lacebark Elm	25' Cal.	B4B
(•)	FX	Fothergilla x intermedia 'Mount Airy'	Mount Airy Fothergilla		#8
Ŏ	JX	Juniperus x media 'wardii'	Mardii yew	24" Ht.	
$\odot$	VM2	Viburnum carlesii 'SMVCB'	Spice Baby± Koreanspice Viburnum		#3
ECIDUO	US SHRU				
$\odot$	H5	Hydrangea quercifolia 'Sike's Dwart'	Sike's Dwarf Oakleaf Hydrangea	24" Ht.	#8
$\bigcirc$	R6	Rhus aromatica 'Gro-Low'	Gro-Law Fragrant Sumac		#8
$\mathcal{A}$	RT	Rosa x 'Red Drift'	Red Drift Rose		#3
	VM	Viburnum dentatum 'Blue Muffin'	Blue Muffin Viburnum	24" Ht.	#5
VERGRE		JBS Juniperus chinensis 'Sea Green'	Sea Green Juniper	04111	#5
	JF	Juliperus virginiana 'Grey Owl'	Grey Oxil Juniper	24" Ht.	
	20	anipero virginiana oregioni	orey on surper	18" Ht. Min.	#3







# New Facility

Central Bank e Star Parkway and Ambassa Lenexa, KS 66219

Final Development Plan

LANDSCAPE PLAN L101

### SOD INSTALLATION NOTES: 1) FINISHED GRADES SHALL BE ACCURATE. 2) CULTIVATE ENTIRE AREA TO A MINIMM 6" DEPTH, EXCEPTIONS TO AREAS MAY BE MADE IF THEE ROOTS ARE EXCONTERED WITHIN THE DRIPLINE OF EXISTING TREES. HAND RAKE SMOOTH. 8) ADD ADDITIVES (AS PER SOIL TEST RECOMMENDATIONS) AND TILL INTO SOIL SOD INSTALLATION SCALE: N.T.S. PERENNIAL PLANTING NOTES: 1) BREAK UP EXISTING TOPSOIL TO A DEPTH OF 24" SPACING DIAGRAM ) PROVIDE NEW TOPSOIL TO A DEPTH OF 18" B) THOROUGHLY MIX PEAT IN TOP 8-4" OF SOIL B) PLACE PLANT IN VERTICAL PLIMB )) BACKFILL W SOIL AND PACK FIRMLY BY HAND. ADD ROOT STIML ATOR FER MANUFACTURERS FEECOMMENCATIONS. VATER THOROUGHLY TO THISH PACKING SOIL AROUND ROOTS. REMOVE CONTAINER PERENNIAL PLANTING SCALE: N.T.S. SHRUB PLANTING NOTES: 1) SET SHRUB AT SAME DEPTH AT MHCH IT GREW IN THE FIELD OR CONTAINER. PLACE PLANT IN VERTICAL PLUMB 2) PRINE, THIN & SHAPE SHRUBS IN ACCORDANCE W/ STANDARD HORTICILITURAL PRACTICE PRINE BROKEN AND DAM TWIGG AFTER PLANTING - 4" THE AYER MECH PEEL BACK BURLAP FROM TOP OF ROOTBALL OR REMOVE CONTAINER BACKFILL WITH EXCAVATED SOIL &

EVERGREEN TREE PLANTING T) EACH TREE MUST BE PLANTED SUCH THE TRUNK. PLANTED SUCH THE TRUNK. PLANTED SUBJECT AT THE TOP OF THE ROOT BALL. TREES HERREE THE FLARE IS NOT VISIBLE SHALL BE REJECTED. DO NOT COVER THE TOP OF THE ROOT BALL. W. SOIL. 8) SOAK BACKFILL AFTER 8) USE 1-1/2" WIDE WEBBING W/ METAL GROMMETS 2 EVERGREEN TREE PLANTING SCALE: N.T.S.

TREE AT PROMING, MUNE ONLY
CROSSOVER LIMBS, CO-DOMINANT
LEADERS & LABROKEN OR DEAD
BRANCHES, SOME INTERIOR THISES
& LATERAL BRANCHES MAY BE
PRUNED IF REGULARED. DO NOT
REMOVE THE TERMINAL BUDS OF
THE DRANCHES THAT EXTENT TO
THE EDGE OF THE CROWN.

2) MARK THE NORTH SIDE OF THE TREE IN THE NURSERY AND ROTATE TREE TO FACE NORTH AT THE SITE WHENEVER POSSIBLE.

A) PLANTING DEPTH OF ROOTBALL SHALL BE EQUAL TO ITS ORIGINAL PLANTING DEPTH AT NURSERY.

PLACE ROOTBALL ON TAMED SOIL.

THE SCANATIO OF TAMED SOIL.

WITH SOIL EXAMED FROM HOLE 4 SPECIFIED AMENDMENTS.

5) SET TOP OF ROOT BALL I-2
INCHES HIGHER THAN SURROUNDING

SCALE: N.T.S.

5 DECIDUOUS TREE PLANTING



6) SOAK BACKFILL AFTER PLANTING.

3) USE I-I/2" MIDE MEBBING W/ METAL GROMMETS

eX en Facility Bank, New Central

Central Bank Parkway and Ambass Lenexa, KS 66219

## LANDSCAPE NOTES


- THE LANDSCAPE CONTRACTOR SHALL READ ALL LANDSCAPE PLANS, SPECIFICATIONS AND VISIT THE PROJECT SITE TO BECOME FAMILIAR WITH EXISTING CONDITIONS PRIOR TO BIDDING THIS PROJECT.
- 2.ANY AND ALL QUESTIONS CONCERNING THE LANDSCAPE PLANS AND SPECIFICATIONS SHALL BE DIRECTED TO THE LANDSCAPE ARCHITECT.
- 3.THE LANDSCAPE CONTRACTOR IS TO VERIFY THE LOCATION OF ALL UNDERGROUND UTILITIES (INCLUDING THOSE INDICATED ON THE PLAN) PRIOR TO INSTALLATION OF PLANT MATERIAL.
- THE LANDSCAPE CONTRACTOR SHALL BE RESPONSIBLE FOR WATERING, MULCHING, AND OTHER REQUIREMENTS OF PLANT MATERIALS WHILE THEY ARE TEMPORARILY STORED ON OR OFF SITE.

- ALL LANDSCAPE MATERIAL SHALL MEET THE AMERICAN STANDARD FOR NURSERY STOCK (ANSI Z60.1-1996) PER THE AMERICAN ASSOCIATION OF NURSERYMEN.
- 5.THE LANDSCAPE ARCHITECT RESERVES THE RIGHT TO INSPECT ALL PLANT MATERIAL AT THE NURSERY PRIOR TO SELECTION OR DISGING, AT THE OWNER'S REQUEST.
- CONDUCT PLANTING INDER FAVORABLE MEATHER CONDITIONS DIRING EITHER THE SPRING PLANTING SEASON MARCH TO JUNE I, OR THE FALL PLANTING SEASON, SETTIPIERS SO LIVING PRESENCE OF THE GROUND, DURING THE FALL PLANTING SEASON, CONTRIBUTIONS METHOD. THE SEASON PLANTING SEASON SETTIMENT OF THE SEASON OF THE SEASON OF THE SEASON SETTIMENT OF THE LANDSCAPE PLANTING DATES WILL ONLY BE PERMITTED WITH APPROVAL IN WRITING BY THE LANDSCAPE ARCHITECT.
- O. ROOT STIMULATOR SHALL BE APPLIED TO ALL PLANT MATERIALS WITH THE EXCEPTION OF LAWN AREAS. APPLY PER THE MANUFACTURERS SPECIFICATIONS.
- I. THE PLANTING SOIL MIXTURE FOR ALL TREE PLANTINGS SHALL INCLUDE SOIL\ EXCAVATED FROM THE HOLE. RATIO, 50% VIRGIN SOIL + 50% AMENDED TOP SOIL.
- IS ALL TEE SAUCES AND PLANTING BEDS AND TO BE MALOUDD WITH A MINIMAN OFF 4"

  DOLLE-GROUPD MANDROOD MALO (LOCAL OF THE DAKE SHOWN) MULES NOTHER OFFICE OFFI DOLLE-GROUPD MANDROOD MALO (LOCAL OF THE DAKE SHOWN) MULES NOTHER OFFI DOLLE-GROUPD MANDROOD MALO (LOCAL OF THE DAKE SHOWN) MULES NOTHER OFFI REVISIO PRICE TO INSTALLATION, MUREE PLANTING BEDS AND ADACTOR TO MALOS AND CURSES THE SOIL LEVEL SHALL BE S' LONGE TO ALLONG FOR MULL LANTER, WEREE SOI IS INDICATED, TO TRICKNESS SHALL, ALSO BE ACCOUNTED FOR SO THAT THE SOIL SAFFACE IN THE SOID IS \$\frac{1}{2}\$ EXPENSE.

- 14. THE LANDSCAPE CONTRACTOR SHALL RESTORE FINISH GRADES IN ALL PLANTING AREAS (PER GRADING PLANS) WHICH MAY HAVE BEEN DISTURBED DURING PLANTING OPERATIONS.
- IS. MILCH, STAKES, GUY WIRE, PRE-EMERGENT HERBICIDES, ETC. SHALL BE SUBSIDIARY TO INDIVIDUAL PLANTS.

- 17. LOOSEN SOIL FOR ALL PLANTING ISLANDS AND SHRUB/PERENNIAL BEDS TO A DEPTH OF 12".
- 18. TOPSOIL SHALL BE FERTILE NATURAL TOPSOIL, TYPICAL OF THE LOCALITY, OBTAINED FROM MELL DRAINED AREA, STOCKPILED TOPSOIL MAY BE USED, IT SHALL BE KITHOUT ADMITS. OF THE STOCKS, EMANS TOKKS, FILANTS OR THEIR ROC TOXIC SUBSTANCES OR OTHER EXTRACED ON THE TRATH THAT BE HARPFUL TO FLANT GROW OR WOLD, INTERPRETE HITH FILANT BROWN FROLD, THAT BROWN FROLD, THE STORT FROLD, THAT BROWN FROLD, THE STORT FROLD, THAT BROWN FROLD, THE STORT FROLD, THAT BROWN FROLD, THE STORT FROLD, THAT BROWN FROLD, THE STORT FROLD, THE S
- THE LANDSCAPE CONTRACTOR WILL BE RESPONSIBLE FOR THE COLLECTION, REMOVAL, AND COPER DISPOSAL OF ANY AND ALL DEBRIS SENERATED DURING THE INSTALLATION OF THE NOSCAPE CONSTRUCTION.
- 21. COORDINATE WITH THE OWNER AND GENERAL CONTRACTOR FOR SLEEVE LOCATIONS AND TIMING OF SLEEVE INSTALLATION. 22. DEWITT PROS WEED BARRIER SHALL BE INSTALLED BETWEEN ALL STONE GROUNDCOVER AREAS AND UNDERLYING SOIL SURFACE.
- 23, SOD LAWN AT ALL DISTURBED AREAS, INCLUDING THOSE NOT NECESSARILY INDICATED ON THIS PLAN
- 25. NO TREE, SHRUB, OR MOODY VESETATION WILL BE PLANTED WITHIN A DISTANCE OF IO FEET FROM ANY FIRE HYDRANT OR FIRE DEPARTMENT CONNECTION (FDC).
- 26. NO TREES WILL BE PLANTED WITHIN IS FEET OF A STREETLIGHT.
- 27. ANY LANDSCAPE MATERIALS TO BE USED FOR SCREENING MUST BE AT LEAST THE HEIGHT OF THE MATERIAL THAT IT IS INTENDED TO SCREEN.

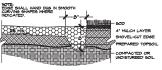

SHOVEL-CUT EDGING

SCALE: N.T.S.

SCALE: N.T.S.



LANDSCAPE NOTES & DETAILS L102

















# Central Bank, Lenexa New Facility Central Bank Prairie Star Perform and Ambassacor Drive Lenexa, NS 962385

Final Development Plan

Color Renderings A-001



**bya** SLAGGIE ARCHITECTS, INC. ⊘ 1004 Konsas Chy, Wissouri € Ombo, Nebraska 888-755-1958 Slaggle.com



New Facility Central Bank is Star Parkway and Ambass:

231001

Final Development Plan

Exterior Elevations

A-201





May 6, 2024


### RESERVE AT COPPER CREEK

Project #: PL24-07F and PT24-06F Location: Northwest corner of 89th Street and

Woodsonia Drive

Applicant: Doug Ubben, Phelps Engineering Project Type: Final Plan and Final Plat

Staff Planner: Dave Dalecky Proposed Use: Multifamily Residential

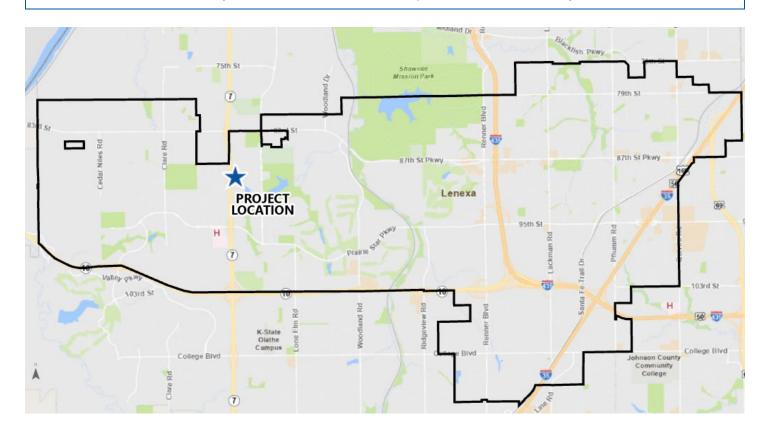

### PROJECT SUMMARY

The applicant seeks approval of a final plan for The Reserve at Copper Creek, a multifamily residential development located at the northwest corner of 89<sup>th</sup> Street and Woodsonia Drive. The plan is for the first phase of the development containing 289 units among eight buildings. The Reserve at Copper Creek project is zoned within the RP-3, RP-4, and RP-5 Zoning Districts. The graduated zoning districts increase in intensity from east (Woodsonia Drive) to west (K-7 Highway). This first phase is the northerly part of the development and includes all three districts. Each phase will include a clubhouse and pool amenity incorporated into one of the apartment buildings. The proposed final plan is consistent with the approved preliminary plan/plat (PL24-03P), which includes a deviation for setback reduction along building setback from K-7 Highway. The submittal includes the final plat of the first phase. This project does not require a Public Hearing.

STAFF RECOMMENDATION: APPROVAL WITH A CONDITION



### SITE INFORMATION

This site is the first phase of the Reserve at Copper Creek multifamily development. This phase is the northerly part of the project and contains 14.41 acres of land. The site is at the northwest corner of the intersection of 88<sup>th</sup> Street and Woodsonia Drive. The property was zoned for multifamily development in 2021 with an associated concept plan (RZ21-06, RZ21-07, PL21-05CP, and PL21-06CP) and a preliminary plan approved in the spring of 2024, (PL24-03P). The site has three multifamily zoning districts, RP-3, RP-4, and RP-5 that are configured to increase in intensity from east to west. The development will require the completion of Woodsonia Drive from 83<sup>rd</sup> Street to Prairie Star Parkway. Conditions related to the timing and completion of Woodsonia Drive are included with Staff's recommendation at the end of the report.

LAND AREA (AC) 14.41 **DWELLING UNITS** 289

CURRENT ZONING RP-3, RP-4, RP-5 **COMP. PLAN**Office/Employment Center



Exhibit 1: Aerial Image of Subject Site



### LAND USE REVIEW

The site is designated for office and employment center uses on the Future Land Use Map of the Comprehensive Plan. The site was considered for the potential of multifamily uses as an alternative to office use from the time the Watercrest Landing single-family subdivision was zoned to RP-1 for single-family development. The site was zoned to three multifamily zoning districts: RP-3, RP-4, and RP-5. The zoning is in a tiered pattern that progressively increases in density from east to west.



TABLE 1: COMPARISON OF SURROUNDING PROPERTIES				
Vicinity	Land Use Designation	Zoning	Current Use	
Subject Property	Office/Employment Center	RP-3, Residential Planned (Medium-Density) District, RP-4, Residential Planned (High-Density) District, and, RP-5, Residential Planned (High-Rise, High-Density) District	Undeveloped land	
North	Public/Open Space	RP-1, Residential Planned Single-Family (Low-Density) District	Church, Westside Family Church Campus	
South	Office/Employment Center	RP-3, Residential Planned (Medium-Density) District	Undeveloped land	
East	Office/Employment Center, Medium Density Residential, Suburban Density Residential, and Low-Density Residential	RP-1, Residential Planned Single-Family (Low-Density) District, RP-2, Residential Planned (Intermediate Density), and CP-2, Planned Community Commercial District	Single-Family Subdivision, Watercrest Landing	
West	Medium Density Residential (across K-7 Highway)	RP-3, Residential Planned (Medium-Density) District (across K-7 Highway)	Multifamily Residential, Townhomes at the Reserve (across K-7 Highway)	



### FINAL PLAN REVIEW

The proposed development is the first phase of the Reserve at Copper Creek multifamily residential development. The overall project contains 529 units on 27 acres and this first phase contains 289 units on 14.41 acres. This phase contains eight buildings; the buildings are consistent with the approved preliminary plan. The easterly part of the site, zoned RP-3, contains three, two-story buildings. The central part contains two- and three-story buildings and the westerly part of the site contains two four-story buildings. The clubhouse and pool amenity are attached to an apartment building in the central part of the site. An additional amenity is a dog park located at the northeast corner of the site.

This phase of the development will have three access drives onto Woodsonia Drive. The drives will align with the streets in Watercrest Landing. The northerly street is a cul-de-sac, and the other two streets are indirect connections to Monticello Road. The intent is to discourage circulation through Watercrest Landing to access the Reserve at Copper Creek development. The most efficient means to access the sounding street network is to travel either north or south on Woodsonia Drive to 83<sup>rd</sup> Street or Prairie Star Parkway. All construction traffic is required to use Woodsonia Drive to access this site.

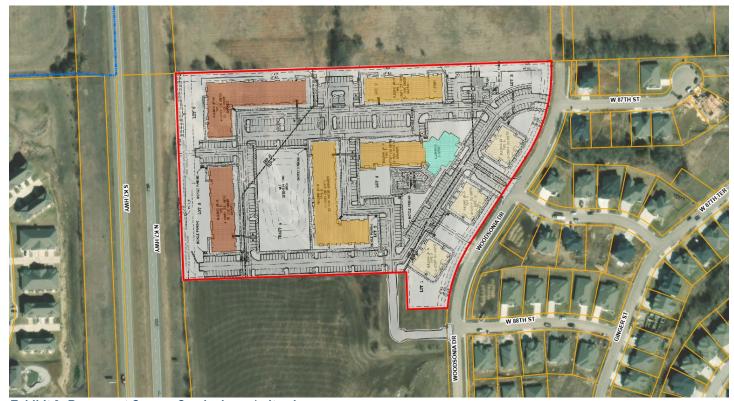


Exhibit 2: Reserve at Copper Creek phase 1 site plan.



### **PUBLIC IMPROVEMENTS**

The development is required to complete Woodsonia Drive from 83<sup>rd</sup> Street to Prairie Star Parkway. Sections of the street are currently in place. The incomplete sections of Woodsonia Drive must be built prior to the issuance of any form of Certificate of Occupancy, including Temporary Certificate of Occupancy for the buildings.

Permits and/or construction activity prior to completion of the full Woodsonia Drive, based on an approved access gained from the incomplete section of Woodsonia Drive at the north end of the site, may be possible. Approval of the project is conditional of the completion of the sections of Woodsonia Drive.



Exhibit 3: Woodsonia Drive sections.



### **PARKING**

The development will include surface parking and "tuck-under" garage spaces for residents and visitors. The overall project requires 962 parking spaces. The preliminary plan exceeds the minimum parking requirement by 21 parking spaces. The first phase of the development provides 537 parking spaces, exceeding the minimum parking requirement by 10 parking spaces. Bicycle parking (a paved space with bike racks) will be located throughout the development next to each apartment building. A space, or multiple spaces, where groups of four bike racks will be located next to each apartment building.

TABLE 3: PARKING ANALYSIS					
Land Use	Parking Formula	Required Parking	Proposed Parking	Difference	
Multifamily 17 efficiency units 154 1-bedroom units 118 2-bedroom units 212 total units	1 space per efficiency unit 1.5 space per 1-bedroom unit 1.75 spaces per 2-bedroom unit 2 spaces per 3+ bedroom unit .25 spaces per unit for visitors	527	537	+ 10	
Bicycle 289 total units	1 space per 5 units	58	60	+ 2	

### STORMWATER

The applicant submitted a final stormwater management plan/study for the proposed property that indicates the intent to meet the City's stormwater standards and requirements.

### FIRE PREVENTION

The Fire Department reviewed the plans based on the current adopted fire codes and local amendments. All general planning review comments have been acknowledged or satisfied and there are no outstanding Fire Department planning review items that need to be addressed for this project to move forward. A more detailed fire code review will be conducted based on the adopted codes at the time of the building permit documentation submittal.

### LIGHTING

The site will contain parking lighting throughout the parking lot and additional site lighting with building mounted fixtures and other decorative light fixtures for sidewalks and pedestrian areas. A photometric plan has been provided that complies with the light requirements <u>Section 4-1-C-4-I</u> of the Unified Development Code (UDC). Parking lot light fixtures shall use shields for the fixtures along the periphery of the site to reduce light spilling onto adjacent development.

### LANDSCAPING

The site will have substantial landscaping around the periphery, throughout the parking areas and around each building. The City Council approved the Preliminary Plan with additional conditions. One of the conditions related to the provision of a landscape buffer along Woodsonia Drive. The landscape plan shows the required Land Use Intensity (LUI) landscape buffer is provided. The preliminary plan showed some of the required landscaping outside of the 20-foot buffer, further from Woodsonia Drive. The plan is now revised so that all the required landscaping is within the 20-foot buffer. The relocation of the landscape materials increases the amount of plantings between the first apartment buildings and the street.





Exhibit 4: Landscape Buffer along Woodsonia Drive (highlighted in green).

In addition to the required LUI buffer, peripheral landscaping and parking lot landscaping, each building will have foundation landscaping installed. The foundation landscaping will include smaller materials and ornamental plantings. The landscape for the first phase complies with the landscape requirements of <u>Section 4-1-D-2</u> of the UDC.

A monument sign is shown in the island of the main drive entrance to the site. The island will also have landscaping including ornamental plantings around the base of the site. The sign will require a separate sign permit.



### ARCHITECTURE

The overall development consists of two phases. Each phase will have a unique style of architecture. This northern phase is a contemporary style of architecture. The buildings incorporate geometric forms with long horizontal lines. The roof lines are interrupted with low pitched articulations. The material palette is brick, stucco, lap siding, vertical and horizontal oriented metal panel, and wood panel. The building colors are gray, light tan, green and brown. The buildings may use a mix of colors to provide differentiation among the buildings. The additional colors will be in the same family of earth tone colors.



Exhibit 5: Three-story apartment building elevation.

The buildings contain several plane changes and variation along the façades, multiple window sizes and use of accents and detail elements. The buildings will have metal railing around the patio spaces and a metal awning above the top floor windows. The patios and awnings will use a suspended detail as a design element to carry the modern style motif.

The clubhouse and pool amenity are interconnected with one of the apartment buildings. The clubhouse is a one-story structure with clerestory elements. The clubhouse is an easily identified feature of the development.



Exhibit 6: Clubhouse, attached to three-story apartment building.

The development is designed to transition in scale and density from east to west. The buildings along the east side of the site are to be similar in scale and in design features to a single-family house. These buildings will each contain 12 apartments. The buildings are all two-stories and will use pitched roofs with several gables and hip-roof elements. The 12-unit apartment buildings will include several wall articulations and materials changes along the façades to resemble the character of a single-family home.







### RESERVE AT COPPER CREEK - PL24-07F & PT24-06F

Planning Commission Staff Report May 6, 2024



The buildings will be two-, three-, and four-stories tall. The four-story buildings will be on the west side of the site along K-7 Highway. All the building in the first phase will use the same palette of materials, geometric forms, accent features and design details.



Exhibit 8: Four-story apartment building.

The three- and four-story apartment buildings will have garage spaces on the ground floor. These garage spaces are referred to as "tuck-under" garages. The tuck-under garages will span the length of the apartment buildings. The ground floor façade of the building that faces the interior of the site will have a series of garage doors. The site is designed so that the "long" façade of the buildings face north or south, except for the building along the west side of the site so the series of garages are the least visible from Woodsonia Drive.



Exhibit 9: Three-story apartment building with tuck-under garages.

Each building will have a location where electrical meters are mounted. This is referred to as the "meter bank." The meter bank is located at an inconspicuous position on the building so it is not as visible from the street and where landscaping can be used to further obscure visibility of the meters.



### FINAL PLAT REVIEW

A final plat is provided with the final plan. A preliminary plat of the entire site was approved together with the preliminary plan in March 2024 (PL24-03P). This final plat is for the first phase of development.

The 627,905 SF (14.41 ac) plat is divided into eight lots and one tract. The applicant proposes that each building be built within a separate lot. This is not a common development pattern for a multifamily project. The purpose that each building is with its separate lot is due related to the construction of Woodsonia Drive. Each lot is expected to have an assessment for the cost of Woodsonia Drive.

The plat will include easements dedicated to the City and a sewer easement dedicated to Johnson County Wastewater District. Tract A will include a drainage easement. Easements for access and utilities are provided throughout the plat.

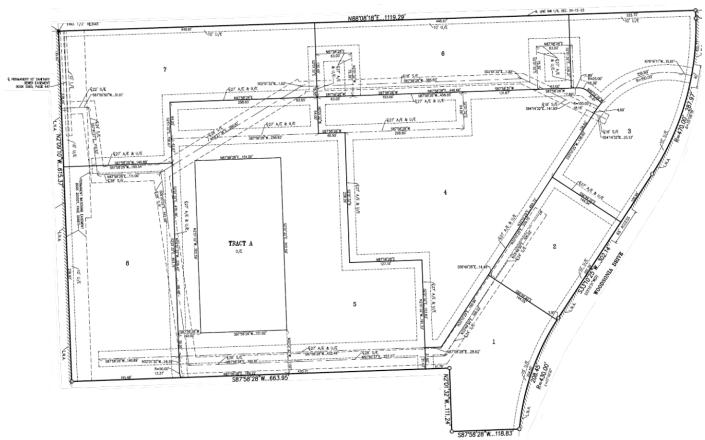


Exhibit 10: The Reserve at Copper Creek Final Plat



A drive entrance that extends to the south of the plat connecting to Woodsonia Drive. This drive entrance is the location of the permanent drive on the next phase of the development. This drive is outside of the plat boundary of the first phase of the project. The access easement will be dedicated by separate document.

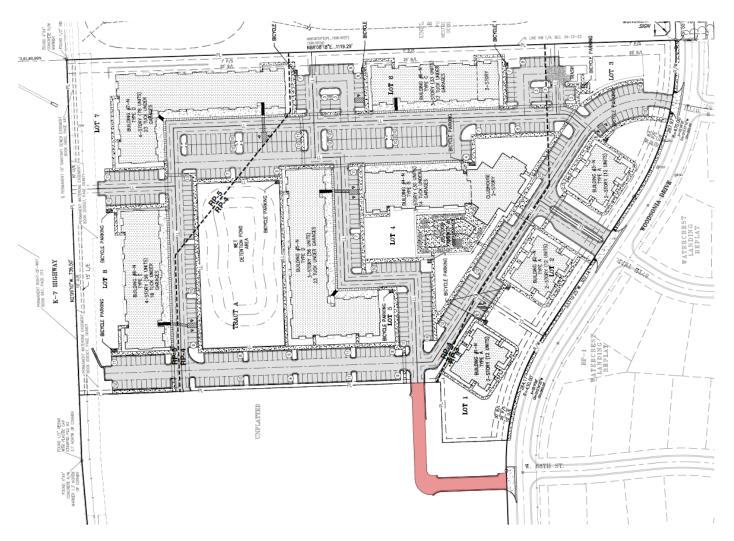


Exhibit 11: Drive extension requires an easement by separate document (shown in red).



### **DEVIATIONS**

The applicant received approval for deviations with the approval of the preliminary plan. The deviation that is included with this first phase of the development is the reduction of the freeway special setback. Section 4-1-B-26-C-1 of the UDC requires a 100-foot setback adjacent to Interstate and State Highways. The project is adjacent to K-7 Highway. At the time of the preliminary plan consideration for the project, a request to reduce this setback was made for parking and for the buildings on the west side of the site. The deviation was granted for the reduction to the setback. The deviation varies for buildings and for parking areas. The buildings encroach into the setback up to 19 feet and the parking encroaches up to 52 feet. This deviation was granted with the preliminary plan.

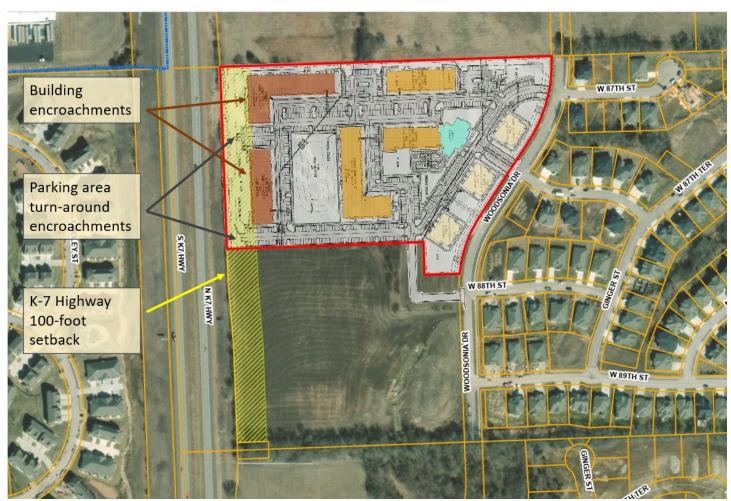


Exhibit 12: Special setback deviations (approved with preliminary plan).



### **REVIEW PROCESS**

- The City Manager has requested the final plan for The Reserve at Copper Creek be considered by the Governing Body. The item is tentatively scheduled for the May 21, 2024 City Council meeting.
  - The City Council added two conditions to the approval of the preliminary plan. One condition regarding the landscape buffer along Woodsonina Drive and a condition that requires the owner/developer to include a statement in the leases that informs the tenants of the Powder Creek shooting range on the east side of Monticello Road indicating and that noise for gunfire from the range will be heard.

### **NEXT STEPS**

- The final plat must be recorded with Johnson County prior to permits being released.
- The applicant must receive permit(s) prior to commencing construction.
- The applicant should inquire about additional City requirements and development fees.

### RECOMMENDATION FROM PROFESSIONAL STAFF

- ★ Staff recommends approval of the proposed Final Plan/Plat for The Reserve at Copper Creek.
  - This is a final plan/plat for a multifamily residential development consisting of five multifamily buildings.
  - The project is consistent with Lenexa's goals through **Responsible Economic Development** to create a **Thriving Economy** and **Vibrant Neighborhoods**.

### FINAL PLAN/PLAT

Staff recommends **approval** of the final plan/plat for PL24-07F and PT24-06F – **The Reserve at Copper Creek** located at the northwest corner of 89<sup>th</sup> Street and Woodsonia Drive for a multifamily residential use with the following condition:

1. Prior to the issuance of any form of Certificate of Occupancy for any building, Woodsonia Drive shall be complete and open to the public from 83<sup>rd</sup> Street to Prairie Star Parkway.



Data Source: City of Lenexa and Johnson County Kansa

# **Reserve at Copper Creek**





Know what's below. Call before you dig.



PHASE COVER SHEET

E AT COPPER CREEK
LENEXA, KANSAS RESERVE

SHEET C0.0

SCALE: 1"=100'





SHEET



GROSS AREA = ±14.4147 ACRES / ±627,904 SQ.FT.

FLOOD NOTE:
THIS PROPERTY LES WITHIN ZONE X, DEFINED AS AREAS DETERMINED TO BE OUTSIDE THE O.ZX ANNUAL CHANCE FLOODFLAIN, AS SHOWN ON THE FLOOD
RIGHARCE RATE MAP PREPARED BY THE FEDERAL EMPRENCY MANAGEMENT AGENCY FOR THE CITY OF LENEXA, COMMUNITY NO. 200168, JOHNSON
COUNTY, KANSAS, MAP NO. 20091000326, AND DATED AUGUST 3, 2009.

 PREPARED & SUBMITTED BY:
 OWNER/DEVELOPER:

 PHELPS ENGINEERING, INC.
 OAK 10 MWSTEMPTS LLC

 1270 N. WINGHESTER
 4000 PERNISTLANIA AVE,

 0.1270 N. BY CONTROL
 4000 PERNISTLANIA AVE,

 913-939-1166 FAX
 SURT 115 ;432

 913-939-1166 FAX
 KANSS GOTV, MO GHILL

 ATTN: ARKON LICHIERDER
 ARKON GONACOM

CHWAY	NW1/4		NET/4	
K-7 MIGHWAY	SW1/4	MONTICELLO RD.	SE1/4	
	PRAIRIE STA	R PA	RKWAY	
I PC	VICINII SEC. 34			SCALE: 1"-2000"




PROPOSED BUILDING \_\_\_\_\_B/L \_\_\_\_\_ BUILDING SETBACK LINE P/S — PARKING SETBACK LINE

PARKING DATA	
	PHASEI
	(Apartments)
Total Units	289
Studio	17
1 Bedroom	154
2 Bedroom	118
Standard Parking Provided	432
Garage Parking Provided	92
Driveway Parking Provided	0
Handicap Parking Spaces Provided (Standard)	10
Handicap Parking Spaces Provided (Garage)	3
Total Parking Provided	537
Number of Parking Spaces per Unit Provided	1.9
Number of Parking Spaces per Unit Required	
Studio (1.00 spaces/unit + 0.25 guest spaces/unit)	17
1 Bedroom (1.50 spaces/unit + 0.25 guest spaces/unit)	231
2 Bedroom (1.75 spaces/unit + 0.25 guest spaces/unit)	207
Guest Spaces(.25 Per Unit)	72
Total Parking Required	527
Handicap Parking Spaces Required	11
Bicycle Parking	
Required	58

		PHAS	SEI	
SITE AREA	652,282 5	.F./	14.97	AC
RP-5	166,750 5	.F./	3.83	AC
RP-4	330,337 9	.F./	7.58	AC
RP-3 (NET)	130,818 9	.F./	3.00	AC
RP-3 (WOODSONIA R/W)	24,377 9	.F./	0.56	AC
RP-3 (GROSS)	155,195 5	.F./	3.56	AC
DWELLING UNITS	289			
RP-5	134			
RP-4	119			
RP-3		36		
ZONING	RP-3/RP-4/RP-5			
DENSITY - UNITS PER ACRE	19	U	NITS/AC	
RP-5	35 UNITS/AC			
RP-4	16 UNITS/AC			
RP-3	10 UNITS/AC			
DENSITY (MAX. PER ACRE RP-5)	36 UNITS/AC			
DENSITY (MAX. PER ACRE RP-4)	16 UNITS/AC			
DENSITY (MAX. PER ACRE RP-3)	12 UNITS/AC			





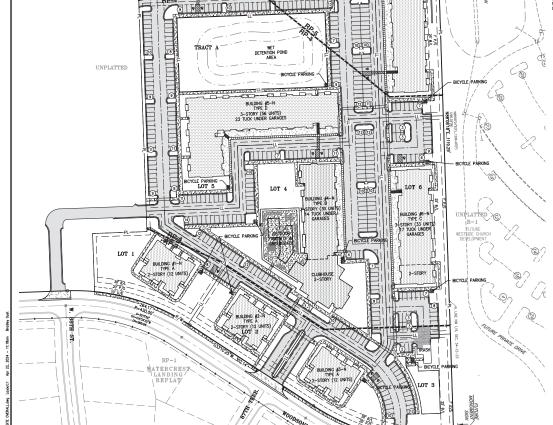

WATERCREST LANDING REPLAT

K-7 HIGHWAY


N2'09'10"W...736.50 

LOT 8

BUILDING #8-N TYPE E 4-STORY (56 UNITS) 18 TUCK UNDER GARAGES

© PERMANENT 10' SANITARY SEWER EASEMENT BOOK 5965, PAGE 447

BUILDING #7-N TYPE D 4-STORY (78 UNITS) 23 TUCK UNDER GARAGES

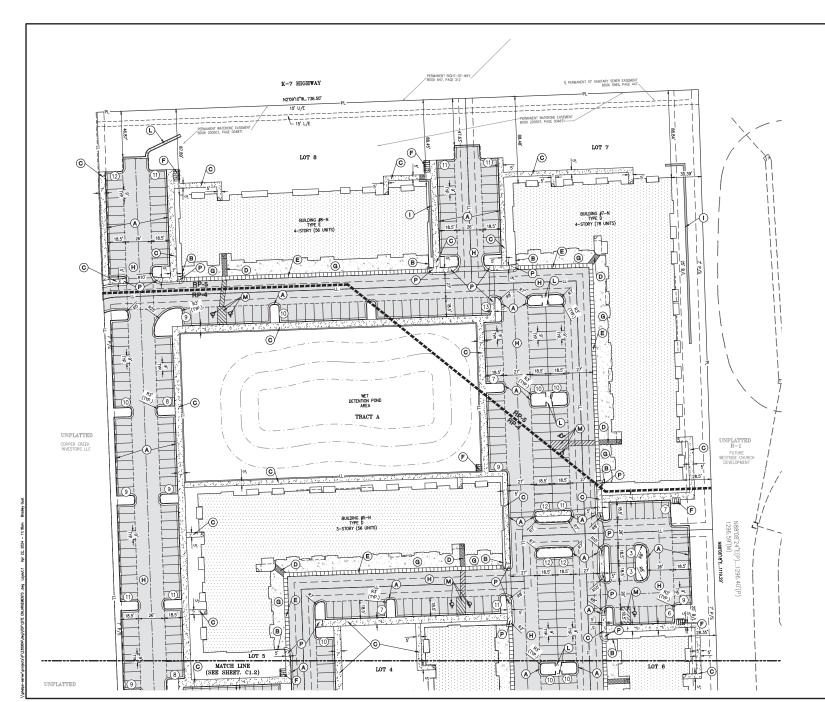



- A CONSTRUCT 2' CURB & GUTTER (TYPICAL).
- B CONSTRUCT 6" CURB (TYPICAL).
- C CONSTRUCT PRIVATE CONCRETE SIDEWALK (TYPICAL).
- D CONSTRUCT COLORED & STAMPED CONCRETE PAVEMENT PEDESTRIAN PATH.
- (E) CONSTRUCT SCORED CONCRETE PAVEMENT PEDESTRIAN PATH.
- F) INSTALL BIKE RACKS W/ CONC. PAD (RE: ARCH. PLANS).
- (H) INSTALL STANDARD DUTY ASPHALT PAVEWENT.
- CONSTRUCT COMMERCIAL CONCRETE ENTRANCE PER CITY STD DETAIL.
- old K construct public concrete sidemalk per city std detail.
- CONSTRUCT CONCRETE GUTTER FLUME.
- (M) CONSTRUCT ACCESSIBLE PARKING SPACE. INSTALL MARKINGS & PARKING SIGN PER STD. DETAIL.
- O INSTALL PUBLIC SIDEWALK RAMP.

### LEGEND

PROPERTY LINE
LOT LINE
RIGHT-OF-WAY -R/W- -STANDARD DUTY ASPHALT PAVENE (1/1/1)

**1969** CONCRETE SIDEWALK

\_\_\_\_\_ B/L \_\_\_\_\_ BUILDING SETBACK LINE


\_\_\_\_ P/S \_\_\_ PARKING SETBACK LINE





SITE PLAN ENLARGEMENT RESERVE AT COPPER CREEK - PHASE LENEXA, KANSAS ͳ

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	Ву	BJG						
	Revisions							
	Date	04-22-2024						
	No.	1.						


PHASE

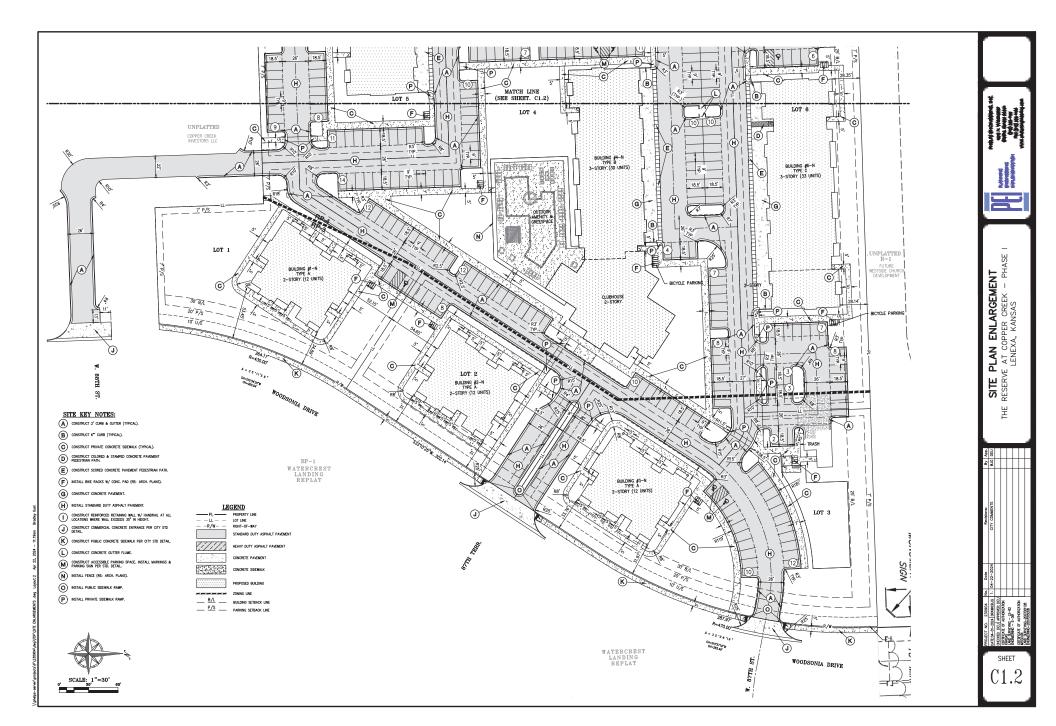
TRUCK TURN PLAN
RESERVE AT COPPER CREEK LENEXA, KANSAS
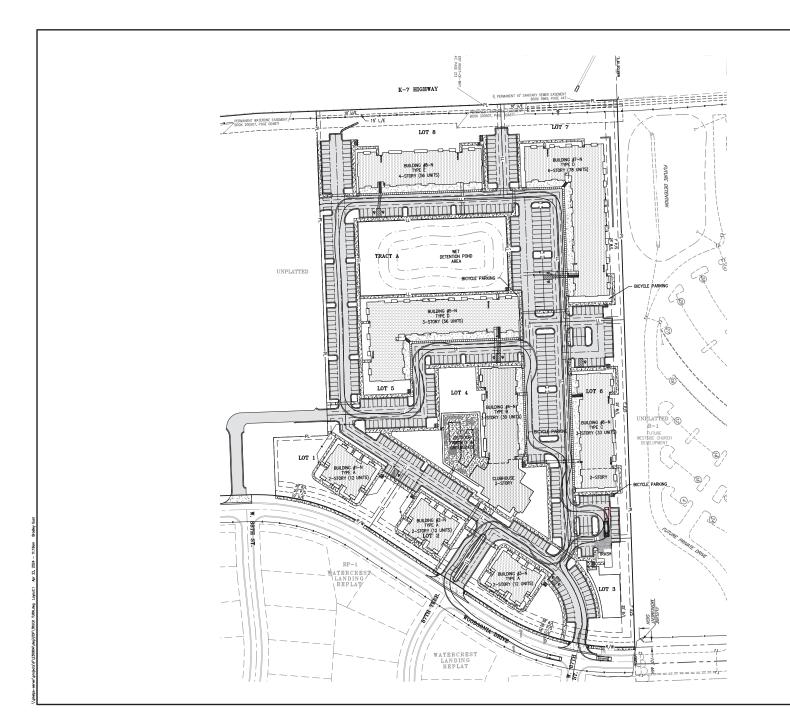
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C1.3

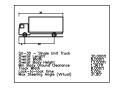



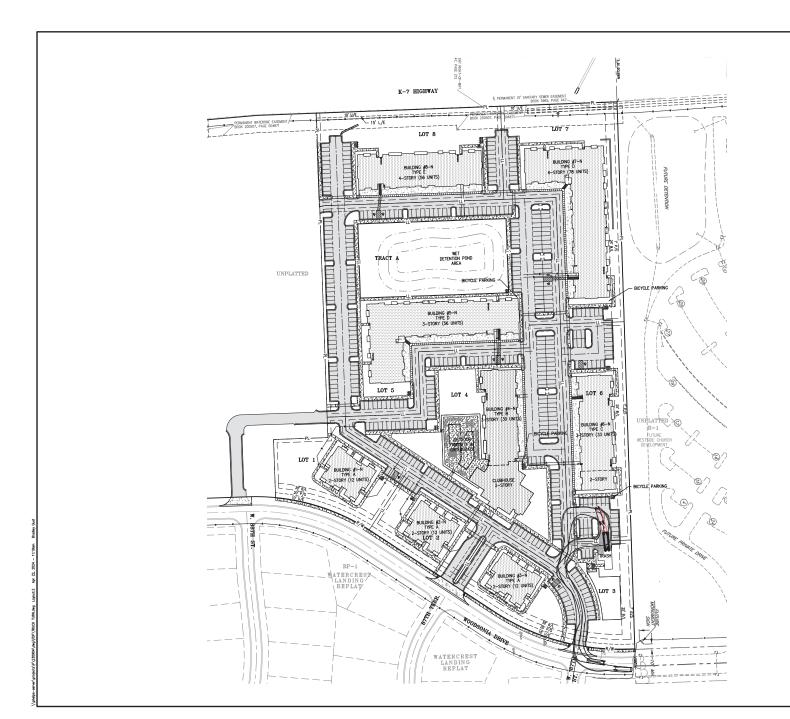

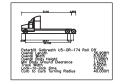

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	Revisions							
	Date	04-22-2024						
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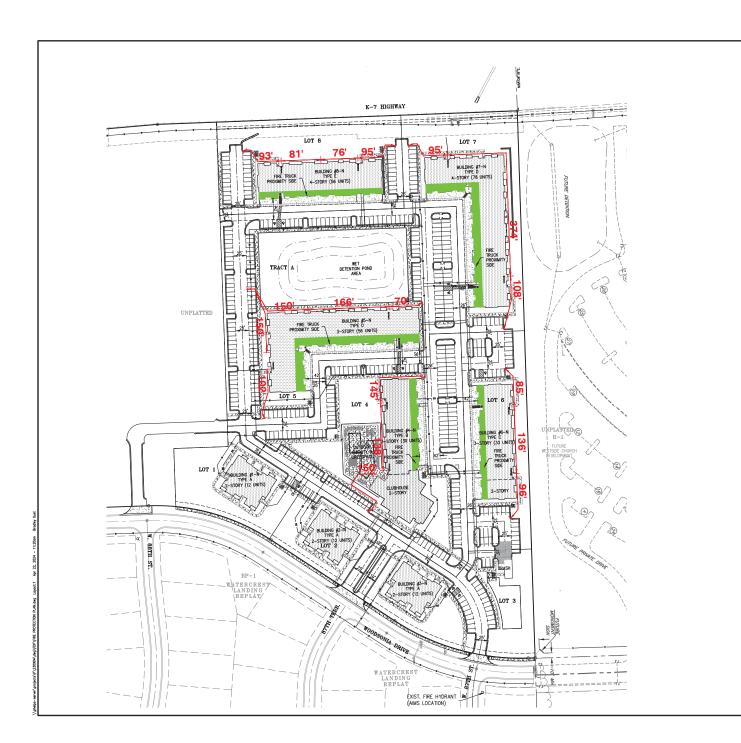
PHASE

TRUCK TURN PLAN
RESERVE AT COPPER CREEK LENEXA, KANSAS

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SHEET





LEGEND:

PL PROPERTY LINE

GENERAL NOTE: ALL DIMENSIONS FROM CURB ARE TO THE FACE OF CURB.

FIRE PROTECTION PLAN
RESERVE AT COPPER CREEK - PHASE
LENEXA, KANSAS

뿔

SHEET C1.5







- LAND DISTURBANCE: The contractor shall othere to all terms & conditions as cullined in the EPA or applicable state N.P.D.E.S. permit for storm water discharge associated with construction activities. Refer to project S.W.P.P.P. requirements.

BENCHMARK: VERTICAL DATUM = NAVD88 BASED ON GPS OBSERVATION USING SMARTNET GPS NETWORK.

1. JOHNSON COUNTY BENCH MARK NO. 289:

TRAVELING WEST ON 95TH STREET FROM 1-35 APPROX. 6.5 MILES TO BRIDGE OVER HWY 7. MONUMENT IS SET ON TOP OF CONCRETE GUARD WALL ON THE SE CORNER ON BRIDGE.

ELEVATION = 1001.55

PLOOD NOTE:
THIS PROPERTY US WITHIN ZONE X, DETINED AS AREAS DETERMINED TO BE
THIS PROPERTY US ANNUAL CHANGE FLOODER AN, AS SKIRM KIN THE FLOO
MISSIANCE RATE MAP PREPARED YOU HE FETDERA DEPROZY MANAGEMENT
AGENCY FOR THE CITY OF LINEXA, COMMUNITY NO. 200168, JOHNSON
OUNTY, KANSAS, AMP NO. 2009FLOOQS, AND DATED JUGUST 3, 2009.

NE1/4

PRAIRIE STAR PARKINA
VICINITY MAP
SEC. 34–12–23
SCALE:
1\*=2000

LEGEND PI PROPERTY UNI 2' CURB & GUTTER

EXISTING CONTOURS PROPOSED CONTOURS


EXISTING STORM SEWER PROPOSED STORM PIPE PROPOSED RETAINING WALL SITE GRADING NOTES:

- C) FILLS: All fills shall be considered controlled or structural fill and shall be free of vegetation, organic matter, topool and debris. In areas where the thickness of the emphered fill is greater than five, feet building and powerent construction should not commence until a cumulative by the on-site gestechnical engineer to allow for consideration.

Know what's below. Call before you dig.

UTILITY NOTES:
WISUAL INDICATIONS OF UTILITIES ARE AS SHOWN.
UNDERGROUND LOCATIONS SHOWN, AS FURNISHED BY THEIR
LESSORS, ARE APPROXIMATE AND SHOULD BE VERRIED IN
THE FIELD AT THE TIME OF CONSTRUCTION. FOR ACTUAL
FIELD LOCATIONS OF UNDERGROUND UTILITIES CALL 811.



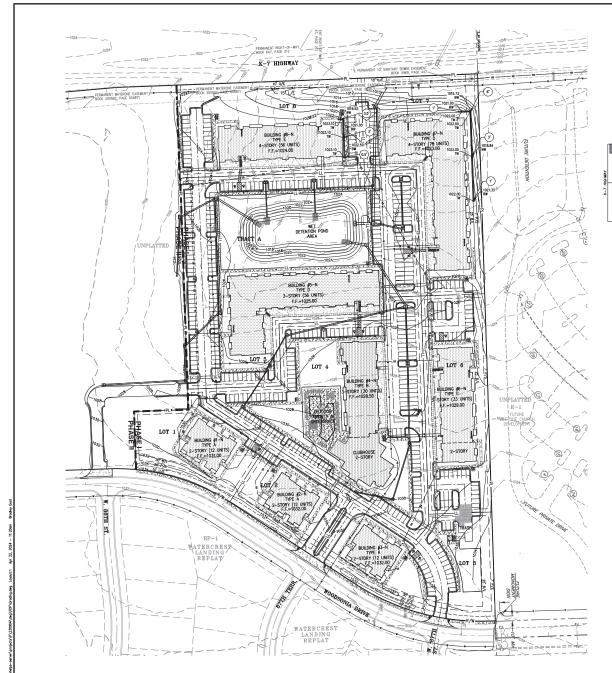

- 1. EACH BIDDER SHALL VISIT THE SITE OF THE PROPOSED WORK AND EXAMINE THE SITE EACH BIDDER SHALL ALSO CAREFULLY EXAMINE THE DRAWINGS FOR THE PROPOSED WORK AND FAMILIARIZE HIMSELF WITH ALL CONDITIONS, WHICH MAY AFFECT THE PROPOSED WORK.
- THE PLANTING PLAN GRAPHICALLY ILLUSTRATES OVERALL PLANT MASSINGS. EACH PLANT SPECIES MASSING SHALL BE PLACED IN THE FIELD TO TUTIZE GREATEST COVERAGE OF GROOM OF THE PLANT OF THE PLANT OF THE SHALL BE A MINIMUM OF F FROM PAVING EDGE.


  B. ALL TREES SHALL BE A MINIMUM OF S' FROM PAVING EDGE.
  C. ALL PLANTS OF THE SAME SPECIES SHALL BE GOULLY SPACED APART AND PLACED FOR BEST AESTHETIC VIEWING.
  D. ALL SHRIVES SHALL BE A MINIMUM OF 2' FROM PAVED EDGE.

  THE PLANT OF THE SAME AND AND THE MINIMUM OF 2' FROM PAVED EDGE.

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- 3. NOTIFY LANDSCAPE ARCHITECT 1 WEEK PRIOR TO ANTICIPATED START OF PLANT MATERIAL INSTALLATION. LANDSCAPE CONTRACTOR SHALL STAKE ALL PROPOSED PLANTING BED EDGES, SET OUT SHRUES IN INTENDED LOCATIONS, AND STAKE TREE LOCATIONS FOR APPROVAL BY LANDSCAPE ARCHITECT PRIOR TO INSTALLATION.
- 4. ALL NEW PLANT BED AREAS TO BE IRRIGATED. REFER TO SPECIFICATIONS FOR IRRIGATION
- 5. REFER TO L1.00 SERIES SHEETS FOR TREE PLANTINGS
- 6. REFER TO L2.00 SERIES SHEETS FOR SHRUB PLANTINGS & ROCK MATERIALS.
- 7. REFER TO L3.00 SERIES SHEETS FOR PLANTING DETAILS & SPECIFICATIONS.
- 8. IN THE EVENT OF WORK IN OR ON THE JCW SANITARY MAIN. ANY TREES OR PLANTINGS PLACED WITHIN THE SEWER EASEMENT MAY BE REMOVED WITHOUT REPLACEMENT OR COMPENSATION THERE OF AND SHALL BE REPLACED BY THE PROPERTY OWNER AS REQUIRED BY THE CITY.
- 9 STRIP TOP SOIL & SAVE FOR PLANTING AREAS. EXCAVATE TO A DEPTH OF 6" FOR ALL PLANTING BEDS AND AMEND WITH PLANTING SOIL MIX. AREAS WITH MORE THAN 18" OF GRAVEL IN PLANT BEDS SHALL BE EXCAVATED TO 18" OR 8" BELOW ROOT BALLS/BOTTOM OF CONTAINER, REFER TO L3.00 FOR PLANTING SOIL MIX
- 10. ROCK BEDS SHALL BE BLIFFALO RIVER BOCK, 1"-2.5" SIZE, BY HOUSE OF BOCKS OR APPROVED EQUAL. ALL ROCK BED AREAS SHALL HAVE FILTER FABRIC & BE 4" MIN. DEPTH
- 11. ALL LANDSCAPE BEDS WITHIN POOL ENCLOSURE TO INCLUDE RIVER ROCK PER SPECS.
- 12. FINISHED GRADE TO BE TOP OF MULCH OR TURF FOR ALL LANDSCAPE AREAS. REFER TO
- 13. ALL LANDSCAPE AREAS NOT IDENTIFIED WITH MULCH, RIVER ROCK, OR OTHER PLANT MATERIAL TO BE SOD. SOD TO EXTEND TO BACK OF CURB FOR ADJACENT PUBLIC STREET.
- 14. STEPPING STONES SHALL BE HICKORY GREY FLAGSTONE AS PROVIDED BY SEMCO MATERIALS OR APPROVED EQUAL. 24\* SQ. MIN. SIZE, 2-3\* THICK.



PLANT LIST 8-10' Hz. B&B 0

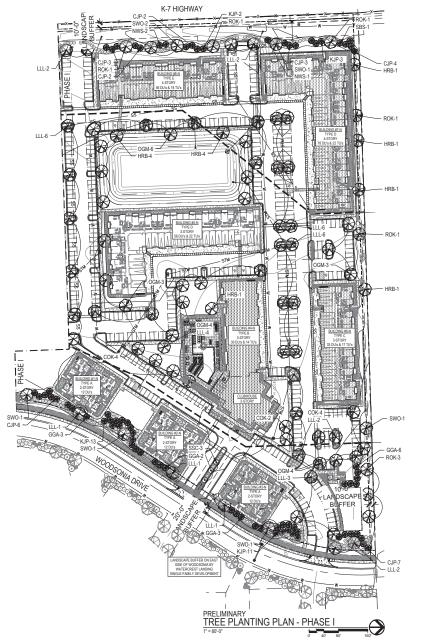MINIMUM CUDI DE DECULIDED ECO DEDIMETED AND DI JECED I ANDROADE DECULIDEMENTO

MINIMUM AREA REQUIRED TO MEET INTERIOR LANDSCAPING OF PARKING LOTS AREA REQUIREMENTS

FOUNDATION PLANTINGS REYOND MIN. REO.

PHASE I - LANDSCAPE REQUIREMENTS (LENEXA)

PERIMETER PLANTINGS (4-1-D-2-L):

1. WEST PROPERTY LINE - ADJACENT TO FREEWAY (K-7) = +/-800 L.F.
REFER TO LAND USE BUFFER REQUIREMENTS.

2. EAST PROPERTY LINE - ADJACENT TO COLLECTOR (WOODSONIA DRIVE) = +/-812 L.F. REFER TO LAND USE BUFFER REQUIREMENTS.

3. NORTH PROPERTY LINE - ALONG LOT LINE = +/-1,119 L.F. REFER TO LAND USE BUFFER REQUIREMENTS.

INTERNAL PARKING LOT LANDSCAPED AREAS (4.1.D.2.M)

ILENNAL PARKING LOT, LANUSCAPED AREAS (4-10-2-M):

1. 10% OF TOTAL PARKING LOT AREA = 207,986 \* 10% = 20,796 SF

2. TTREE PER 300 SF OF OVERALL LANDSCAPED AREA, WITH AT LEAST 1 TREE PLANTED IN EACH ISLAND, THE REMAINDER OF THE ISLAND SHALL BE LANDSCAPED WITH ADDITIONAL TREES, SHRUBS, GROUND COVER OR TURF. PROVIDED: 70 TREES REQUIRED: 20,796 SF / 300 SF = 70 TREES

LAND USE BUFFERS (4-1-D-2-N): 1. NORTH PROPERTY LINE: +/-1,119 L.F.

DUE TO ADJACENT LAND USE I AND USE BUFFER NOT REQUIRED AS INDICATED IN STAFF REVIEW OF FINAL DEVELOPMENT PLAN APPLICATION. STANDARD PERIMETER

EAST PROPERTY LINE (LUI 6)= +/- 813 L.F.
 ADJACENT TO RESIDENTIAL = LUI 1 - INTERVENING R.O.W. COLLECTOR STREET - LUI 2

LUI FAUTUR DIFFERENCE	= 6-1-2 = 3	
	REQUIRED:	PROVIDED:
	20' WIDTH	20' WIDTH MIN.
813 L.F. / 100 = 8.13 * 1	8 SHADE TREES	8 SHADE TREES N
813 L.F. / 100 = 8.13 * 6	49 EVERGREENS	49 EVERGREENS I
813 I F / 100 = 8 13 * 20	163 SHRUBS	163 SHRUBS MIN

3 WEST PROPERTY LINE = +/- 615 LE

DUE TO ADJACENT LAND USE, LAND USE BUFFER NOT REQUIRED AS INDICATED IN STAFF REVIEW OF FINAL DEVELOPMENT PLAN APPLICATION. STANDARD PLANTINGS USED.

PERIMETER PLANTS (4-1-D-2-L)

NORTH PROPERTY LINE = +/- 1,119 L.F. BUILDING AND OPEN AREA = +/- 883 L.F. / 100 L.F. = 8.83

PROVIDED: 9 SHADE TREES 8.83 X 1 SHADE TREE PARKING LOT AREA = +/- 236 L.F. / 100 L.F. = +/- 2.36

2.36 X 1 SHADE TREE 2.36 X 9 SHRUBS 21 SHRUBS 21 SHRUBS MIN

WEST PROPERTY LINE (ADJACENT FREEWAY) = +/- 615 L.F

BUILDING AND OPEN AREA = +/- 4		DDG UDED
	REQUIRED:	PROVIDED:
4.89 X 1 SHADE TREE	5 SHADE TREES	5 SHADE TREES
4.89 X 3 EVERGREENS TREES	15 EVERGREENS	15 EVERGREEN
4.89 X 12 SHRUBS	59 SHRUBS	59 SHRUBS
DADKING LOT ADEA - ±/ 128 LE	/400 L F = -/ 4 28	

REQUIRED: 1 SHADE TREE 1.26 X 1 SHADE TREE

PROVIDED: 1 SHADE TREES 1.26 Y 3 EVERGREENS TREES 4 EVERGREENS 4 EVERGREENS 1.26 X 3 SHRUBS 4 SHRUBS



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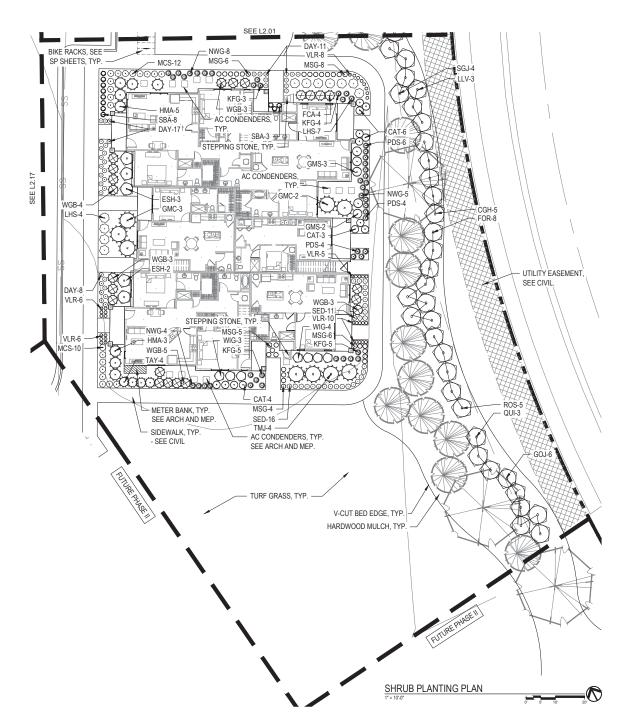
LENEXA, KANSAS


PER CREEK ST. & WOODSONIA RD. MULTIFAMILY DEVELOPMENT RESERVE HE Ы

JOB NO 747723

SHEET NAME TREE PLANTING PLAN - PHASE I SHEET NO

FINAL DEVELOPMENT PLAN L1.00



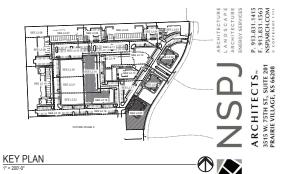

PLANT LIST

Code	Common Name	Botanical Name	Size	Notes
Evergn	een Shrubs			
CGH	China Girl Holly / Boy Holly	llex x meservege 'Mesog' / 'Mesdob'	5 Gal.	5:1 Ratio
FCA	Fire Chief Arborytee	Thuja occidentalis 'Congabe'	5 Gal.	
GMC	Gold Mop Cypress	Chamaecyparis pisifera 'Yellow Thread Branch'	5 Gal.	
GOJ	Grey Owl Juniper	Juniperus virginiana 'Grev Owl'	5 Gal.	
HMA	Hetz Midget Arborvitae	Thuja occidentalis 'Hetz Midget'	5 Gal.	
TMJ	Tam Juniper	Juniperus sabina	5 Gal.	
LLV	Leatherleaf Vibumum	Vibumum rhytidophyllum	5 Gal.	
PFJ	Perfects Juniper	Juniperus chinensis 'Perfecta'	B&B	67 Ht.
SGJ	Sea Green Juniper	Juniperus chinensis 'Sea Green'	5 Gal.	
TAY	Taylor Juniper	Juniperus virginiana Taylor	5 Gal.	
WGB	Winter Green Boxwood	Buxus microphylle 'Winter Green'	B&B	36-48
Decidio	ous Shrubs	7.00		
DGW	Variegated Red Twigged Dogwood	Comus alba 'Ivory Halo'	5 Gal.	
ESH	Endless Summer Hydrangea	Hydrangea macrophylla 'Balmer'	5 Gal.	
FOR	Lynwood Gold Forsythia	Forsythia x intermedia 'Lynwood Gold'	5 Gal.	
GLS	Gro-Low Sumac	Rhus Aromatica	5 Gal.	
GMS	Goldmound Spirea	Spiraea japonica 'Goldmound'	5 Gal.	
KNR	Knockout Rose	Rosa knockout	5 Gal.	
LHS	Little Henry Sweetspire	Itea virginica 'Little Henry'	5 Gal.	
MCS	Magic Carpet Spirea	Spirea japonica 'Magic Carpet'	2 Gal.	
QUI	Flowering Quince	Chaenomeles speciosa Texas Scarlet	5 Gal.	
ROS	Sugar Tip Rose of Sharon/Athea	Hibiscus syriacus 'America Irene Scott'	5 Gal.	
WIG	Fine Wine Weigela	Weigela florida 'Bramwell'	5 Gal.	
Grasse	6			
KFG	Karl Foerster Grass	Calamagrostis x acutiflora 'Karl Foerster'	2 Gal.	
MLG	Morning Light Maiden Grass	Miscenthus sinensis 'Morning Light'	2 Gal.	
NWG	Northwind Switch Grass	Panicum virgatum 'Northwind'	2 Gal.	
PDS	Prairie Dropseed	Sporobolus heterolopis	2 Gal.	
VLR	Varigated Liriope	Liriope muscari variegata	6" pct	
Perenn	ials			
CAT	Catmint	Nepeta x faassenii 'Walker's Low'	1 Gal.	
BES	Black-Eved Susan	Rudbeckia fulgida var. Fulgida	1 Gal.	
DAY	Dayliy	Hemercallis 'Black Eyed Stella' or 'Little Business'	1 Gal.	
RS	Blue Flag Iris	Iris virginica v. shrevei	1 Gal.	
MSG	Meadow Sage	Salvia nemorosa 'May Knight'	1 Gal.	
SBA	Summer Beauty Allium	Alium 'Summer Beauty'	1 Gal.	
SED	Autumn Joy Sedum	Hylotelephium 'Herbstfreude' Autumn Joy	1 Gal	

### GENERAL NOTES:

EACH BIDDER SHALL VISIT THE SITE OF THE PROPOSED WORK AND EXAMINE THE SITE
CONDITIONS. HE SHALL ALSO CAREFULLY EXAMINE THE DRAWINGS FOR THE PROPOSED WOR
AND FAMILIARIZE HIMSELF WITH ALL CONDITIONS, WHICH MAY AFFECT THE PROPOSED WORK.

THE PLANTING PLAN GRAPHICALLY ILLUSTRATES OVERALL PLANT MASSINGS. EACH PLANT SPECIES MASSING SHALL BE PLACED IN THE FIELD TO UTILIZE GREATEST COVERAGE OF GROUND PLANE. THE FOLLOWING APPLIES FOR INDUIAL PLANTINGS.

 A. CREEPING GROUNDCOVER SHALL BE A MINIMUM OF FROM PAVING EDGE.

 B. ALL TREES SHALL BE A MINIMUM OF 3 FROM PAVING EDGE.

 C. ALL PLANTS OF THE SAME SPECIES SHALL BE EQUIALLY SPACED APART AND PLACED FOR BEST ASTHETIC MEMORY.

FOR BEST ASTHETIC VIEWING.

D. ALL SHRUBS SHALL BE A MINIMUM OF 2' FROM PAVED EDGE.

3. NOTIFY LANDSCAPE ARCHITECT 1 WEEK PRIOR TO ANTICIPATED START OF PLANT MATERIAL INSTALLATION. LANDSCAPE CONTRACTOR SHALL STAKE ALL PROPOSED PLANTING BED EDGES, SET OUT SHRUBS IN INTENDED LOCATIONS, AND STAKE TREE LOCATIONS FOR APPROVAL BY LANDSCAPE ARCHITECT PRIOR TO INSTALLATION.

4. ALL NEW PLANT BED AREAS TO BE IRRIGATED. REFER TO SPECIFICATIONS FOR IRRIGATION

5. REFER TO L1.00 SERIES SHEETS FOR TREE PLANTINGS.

6. REFER TO L2.00 SERIES SHEETS FOR SHRUB PLANTINGS & ROCK MATERIALS.

7. REFER TO L3.00 SERIES SHEETS FOR PLANTING DETAILS & SPECIFICATIONS.

8. IN THE EVENT OF WORK IN OR ON THE JCW SANITARY MAIN. ANY TREES OR PLANTINGS PLACED WITHIN THE SEWER EASEMENT MAY BE REMOVED WITHOUT REPLACEMENT OR COMPENSATION THERE OF AND SHALL BE REPLACED BY THE PROPERTY OWNER AS REQUIRED BY THE CITY.

9. STRIP TOP SOIL & SAVE FOR PLANTING AREAS. EXCAVATE TO A DEPTH OF 6" FOR ALL PLANTING BEDS AND AMEND WITH PLANTING SOIL MIX. AREAS WITH MORE THAN 18" OF GRAVEL IN PLANT BEDS SHALL BE EXCAVATED TO 18" OR 8" BELOW ROOT BALLS/BOTTOM OF CONTAINER. REFER TO L3.00 FOR PLANTING SOIL MIX.

10. ROCK BEDS SHALL BE BUFFALO RIVER ROCK, 1"-2.5" SIZE, BY HOUSE OF ROCKS OR APPROVED EQUAL. ALL ROCK BED AREAS SHALL HAVE FILTER FABRIC & BE 4" MIN. DEPTH.

11 ALL LANDSCAPE BEDS WITHIN POOL ENCLOSURE TO INCLUDE RIVER ROCK PER SPECS

12. FINISHED GRADE TO BE TOP OF MULCH OR TURF FOR ALL LANDSCAPE AREAS. REFER TO CIVIL PLANS FOR GRADING INFORMATION.

13. ALL LANDSCAPE AREAS NOT IDENTIFIED WITH MULCH, RIVER ROCK, OR OTHER PLANT MATERIAL TO BE SOD. SOD TO EXTEND TO BACK OF CURB FOR ADJACENT PUBLIC STREET.


14. STEPPING STONES SHALL BE HICKORY GREY FLAGSTONE AS PROVIDED BY SEMCO MATERIALS OR APPROVED EQUAL. 24" SQ. MIN. SIZE, 2-3" THICK.

final development plan L2.00


OPPER CREEK
89TH ST. & WOODSONIA RD. LENEXA, KANSAS DEVELOPMENT FOR AT RESERVE THE

JOB NO. 747723 DATE 04.22.24 BH / MM

SHEET NAME SHRUB PLANTING PLAN - BUILDING #1-N

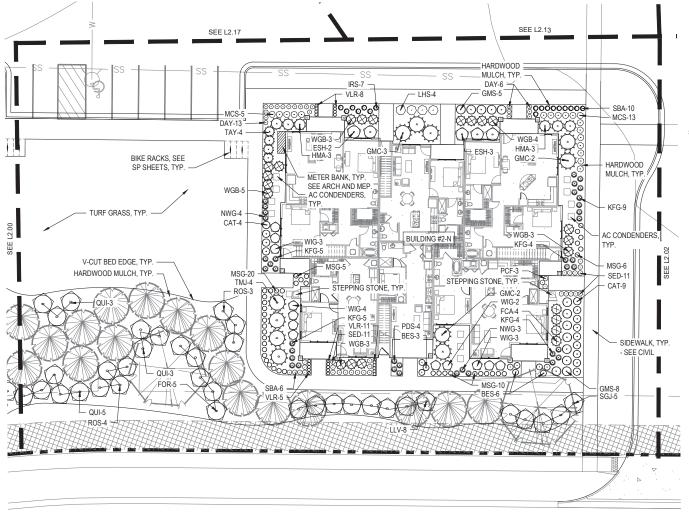

SHRUB PLANTING PLAN

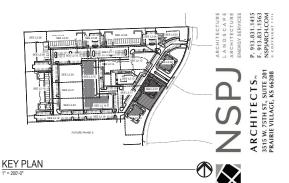

PLANT LIST

	Code	Common Name	Botanical Name	Size	Notes
	Evergr	een Shrubs			
	CGH	China Girl Holly / Boy Holly	llex x meservege 'Mesog' / 'Mesdob'	5 Gal.	5:1 Ratio
	FCA	Fire Chief Arborvitae	Thuja occidentalis 'Congabe'	5 Gal.	
_	GMC	Gold Mop Cypress	Chamaecyparis pisifera 'Yellow Thread Branch'	5 Gal.	
A	GOJ	Grey Owl Juniper	Juniperus virginiana 'Grev Owl'	5 Gal.	
Æ	HMA	Hetz Midget Arborvitae	Thuja occidentalis 'Hetz Midget'	5 Gal.	
gw.	TMJ	Tam Juniper	Juniperus sabina	5 Gal.	
	LLV	Leatherleaf Viburnum	Vibumum mytidophyllum	5 Gal.	
	PFJ	Perfects Juniper	Juniperus chinensis 'Perfecta'	B&B	6" Ht.
	SGJ	Sea Green Juniper	Juniperus chinensis 'Sea Green'	5 Gal.	
	TAY	Taylor Juniper	Juniperus virginiana Taylor	5 Gal.	
	WGB	Winter Green Boxwood	Buxus microphylle 'Winter Green'	B&B	36-48"
	Decidio	ous Shrubs			
	DGW	Variegated Red Twigged Dogwood	Comus alba 'Ivory Halo'	5 Gal.	
	ESH	Endless Summer Hydrangea	Hydrangea macrophyla 'Balmer'	5 Gal.	
	FOR	Lynwood Gold Forsythia	Forsythia x intermedia "Lynwood Gold"	5 Gal.	
<i>-</i>	GLS	Gro-Low Sumac	Rhus Aromatica	5 Gal.	
$\sim$	GMS	Goldmound Spirea	Spiraea japonica 'Goldmound'	5 Gal.	
U	KNR	Knockout Rose	Rosa knockout	5 Gal.	
-	LHS	Little Henry Sweetspire	Itea virginica 'Little Henry'	5 Gel.	
	MCS	Magic Carpet Spirea	Spirea japonica 'Magic Carpet'	2 Gal.	
	QUI	Flowering Quince	Chaenomeles speciosa Texas Scarlet	5 Gal.	
	ROS	Sugar Tip Rose of Sharon Athea	Hibiscus syriacus 'America Irene Scott'	5 Gal.	
	WIG	Fine Wine Weigela	Weigela forida 'Bramwell'	5 Gal.	
	Grasse	6			
	KEG	Karl Foerster Grass	Calamagrostis x acutifora 'Karl Foerster'	2 Gal.	
	MLG	Moming Light Maiden Grass	Miscenthus sinensis 'Morning Light'	2 Gal.	
۵	NWG	Northwind Switch Grass	Panicum virgatum 'Northwind'	2 Gal.	
v	PDS	Prairie Dropseed	Sporobolus heterolepis	2 Gal.	
	VLR	Varigated Lirippe	Liricoe muscari variegata	6" pot	
	Perenr	ials			
	CAT	Cetmint	Nepeta x faassenii 'Walker's Low'	1 Gal.	
	BES	Black-Eved Susan	Rudbeckia fulgida var. Fulgida	1 Gal.	
OD:	DAY	Davilly	Hemercallis 'Black Eyed Stella' or 'Little Business'	1 Gal.	
<b>8</b> 0	RS	Blue Flag Iris	Iris virginica y, shrayei	1 Gal.	
	MSG	Meadow Sage	Salvia nemorosa 'May Knight'	1 Gal.	
	SBA	Summer Beauty Allium	Allum 'Summer Beauty'	1 Gal.	
	SED	Autumn Joy Sedum	Hylotelephium 'Herbstfreude' Autumn Joy	1 Gal.	

EACH BIDDER SHALL VISIT THE SITE OF THE PROPOSED WORK AND EXAMINE THE SITE CONDITIONS. HE SHALL ALSO CAREFULLY EXAMINE THE DRAWINGS FOR THE PROPOSED WORK AND FAMILLARIZE HIMSELF WITH ALL CONDITIONS, WHICH MAY AFFECT THE PROPOSED WORK.

2. THE FLANTING PLAN GRAPHICALLY ILLUSTRATES OVERALL PLANT MASSINGS, EACH PLANT SPECIES MASSING SHALL BEPLACED IN THE FIELD TO UTILIZE GREATEST COVERAGE OF GROUND PLANE. THE FOLLOWING APPLIES FOR INDIVIDUAL PLANTINGS:

A CREEPING GROUNDCOVER SHALL BE A MINIMUM OF F FROM PAVING EDGE.

B. ALL TREES SHALL BE A MINIMUM OF 3 FROM PAVING EDGE.

CONTROL STATEST SHALL BE A MINIMUM OF SHOOL PAVING EDGE.

D. ALL SHRUBS SHALL BE A MINIMUM OF 2' FROM PAVED EDGE.

3. NOTIFY LANDSCAPE ARCHITECT 1 WEEK PRIOR TO ANTICIPATED START OF PLANT MATERIAL INSTALLATION. LANDSCAPE CONTRACTOR SHALL STAKE ALL PROPOSED PLANTING BED EDGES SET OUT SHEWES IN TETENDE LOCATIONS, AND STAKE TREE LOCATIONS FOR APPROVAL BY LANDSCAPE ARCHITECT PRIOR TO INSTALLATION.

4. ALL NEW PLANT BED AREAS TO BE IRRIGATED. REFER TO SPECIFICATIONS FOR IRRIGATION SYSTEM DESCRIPTION.

5. REFER TO L1.00 SERIES SHEETS FOR TREE PLANTINGS.

6. REFER TO L2.00 SERIES SHEETS FOR SHRUB PLANTINGS & ROCK MATERIALS.

7. REFER TO L3.00 SERIES SHEETS FOR PLANTING DETAILS & SPECIFICATIONS.

8. IN THE EVENT OF WORK IN OR ON THE JCW SANITARY MAIN. ANY TREES OR PLANTINGS PLACED WITHIN THE SEWER EASEMENT MAY BE REMOVED WITHOUT REPLACEMENT OR COMPENSATION THERE OF AND SHALL BE REPLACED BY THE PROPERTY OWNER AS REQUIRED

9. STRIP TOP SOIL & SAVE FOR PLANTING AREAS. EXCAVATE TO A DEPTH OF 6" FOR ALL PLANTING BEDS AND AMEND WITH PLANTING SOIL MIX. AREAS WITH MORE THAN 18" OF GRAVEL IN PLANT BEDS SHALL BE EXCAVATED TO 18" OR 8" BELOW ROOT BALLS/BOTTOM OF CONTAINER, REFER TO L3.00 FOR PLANTING SOIL MIX.

10. ROCK BEDS SHALL BE BUFFALO RIVER ROCK, 1"-2.5" SIZE, BY HOUSE OF ROCKS OR APPROVED EQUAL. ALL ROCK BED AREAS SHALL HAVE FILTER FABRIC & BE 4" MIN. DEPTH.

11. ALL LANDSCAPE BEDS WITHIN POOL ENCLOSURE TO INCLUDE RIVER ROCK PER SPECS.

12. FINISHED GRADE TO BE TOP OF MULCH OR TURF FOR ALL LANDSCAPE AREAS. REFER TO CIVIL PLANS FOR GRADING INFORMATION.

ALL LANDSCAPE AREAS NOT IDENTIFIED WITH MULCH, RIVER ROCK, OR OTHER PLANT MATERIAL TO BE SOD. SOD TO EXTEND TO BACK OF CURB FOR ADJACENT PUBLIC STREET.

14. STEPPING STONES SHALL BE HICKORY GREY FLAGSTONE AS PROVIDED BY SEMCO MATERIALS OR APPROVED EQUAL. 24" SQ. MIN. SIZE, 2-3" THICK.

JOB NO. 747723 DATE 04.22.24 BH / MM

SHEET NAME SHRUB PLANTING PLAN - BUILDING #2-N

OPPER CREEK
89TH ST. & WOODSONIA RD. LENEXA, KANSAS

DEVELOPMENT FOR

RESERVE AT

THE

FINAL DEVELOPMENT PLAN L2.01

- EACH BIDDER SHALL VISIT THE SITE OF THE PROPOSED WORK AND EXAMINE THE SITE CONDITIONS. HE SHALL ALSO CAREFULLY EXAMINE THE DRAWINGS FOR THE PROPOSED WORK AND FAMILIARIZE HIMSELF WITH ALL CONDITIONS, WHICH MAY AFFECT THE PROPOSED WORK.
- 2. THE PLANTING PLAN GRAPHICALLY ILLUSTRATES OVERALL PLANT MASSINGS. EACH PLANT SPECIES MASSING SHALL BE PLACED IN THE FIELD TO UTILIZE GREATEST COVERAGE OF OWNER OF THE PLANT OF THE PLANT OF THE ADMINIST EDGE.

  A. CREEPING GROUNDCOVER SHALL BE A MINIMUM OF FFROM PAVING EDGE.

  C. ALL PLANTS OF THE SAME SPECIES SHALL BE COULD'S PAPACED APART AND PLACED FOR BEST ASSINETIO WIEWING.

  D. ALL SPRINGS SHALL BE A MINIMUM OF 2 FROM PAVED EDGE.
- NOTIFY LANDSCAPE ARCHITECT 1 WEEK PRIOR TO ANTICIPATED START OF PLANT MATERIAL INSTALLATION. LANDSCAPE CONTRACTOR SHALL STAKE ALL PROPOSED PLANTING BED EDGES SET OUT SHRIBES IN METNEDE LOCATIONS, AND STAKE TREE LOCATIONS FOR APPROVAL BY LANDSCAPE ARCHITECT PRIOR TO INSTALLATION.
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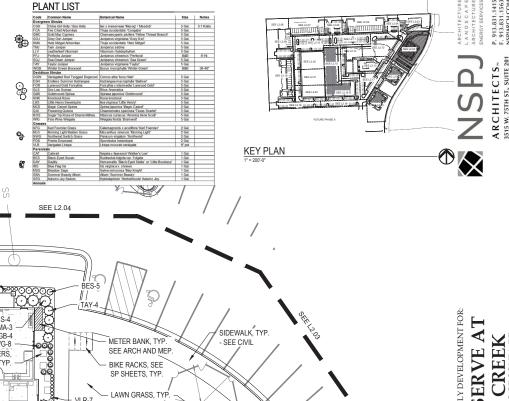
SEE L2.13

- 6. REFER TO L2.00 SERIES SHEETS FOR SHRUB PLANTINGS & ROCK MATERIALS.
- 7. REFER TO L3.00 SERIES SHEETS FOR PLANTING DETAILS & SPECIFICATIONS


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- 10. ROCK BEDS SHALL BE BUFFALO RIVER ROCK. 1"-2.5" SIZE. BY HOUSE OF ROCKS OR APPROVED EQUAL. ALL ROCK BED AREAS SHALL HAVE FILTER FABRIC & BE 4" MIN. DEPTH
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SEE L2.12





SHRUB PLANTING PLAN



SHEET NAME SHRUB PLANTING PLAN - BUILDING #3-N

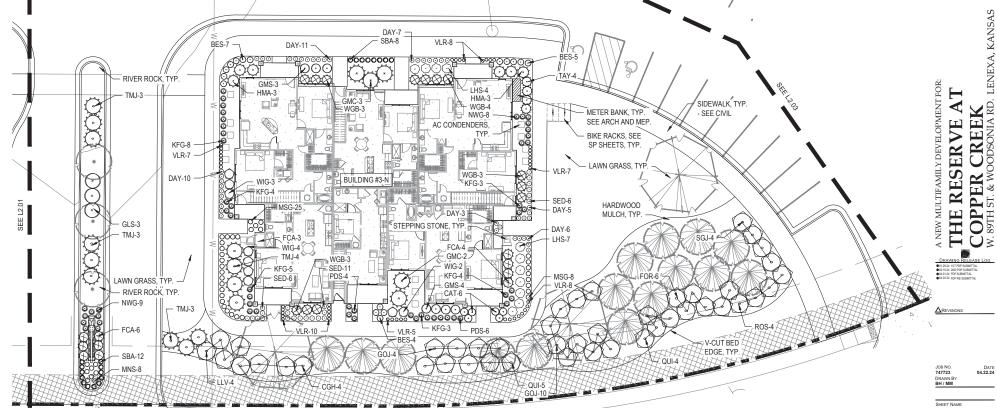FINAL DEVELOPMENT PLAN

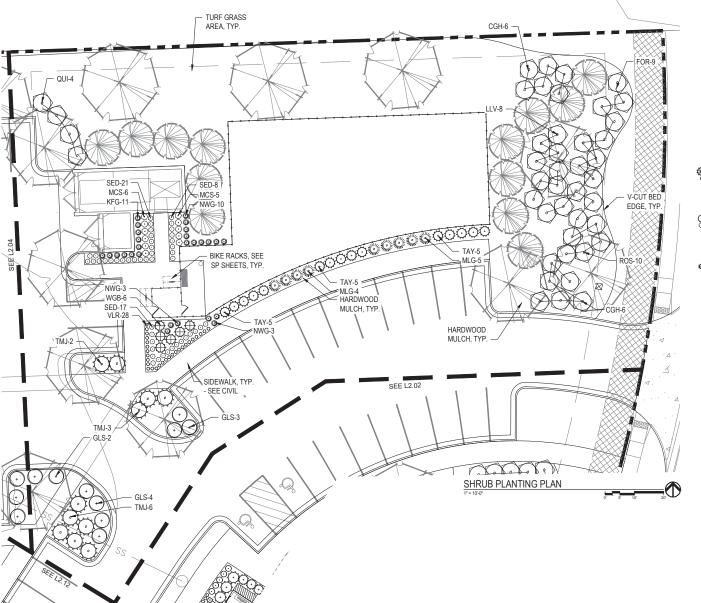

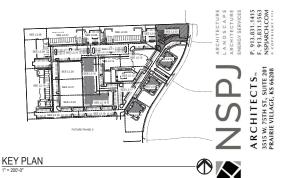

## PLANT LIST

	Code	Common Name	Botanical Name	Size	Notes
	Evergn	een Shrubs			
	CGH	China Girl Holly / Boy Holly	llex x meserveae 'Mesog' / 'Mesdob'	5 Gal.	5:1 Ratio
	FCA	Fire Chief Arborytee	Thuis occidentalis 'Congabe'	5 Gal.	
Br.	GMC	Gold Mop Cypress	Chamaecyparis pisifera 'Yellow Thread Branch'	5 Gal.	
SW2	GOJ	Grey Owl Juniper	Juniperus virginiana 'Grev Owl'	5 Gal.	
494PA	HMA	Hetz Midget Arborvitae	Thuja occidentalis 'Hetz Midget'	5 Gal.	
Ø~	TMJ	Tam Juniper	Juniperus sabina	5 Gal.	
	LLV	Leatherleaf Vibumum	Vibumum mytidophyllum	5 Gal.	
	PFJ	Perfects Juniper	Juniperus chinensis 'Perfecta'	B&B	67 Ht.
	SGJ	Sea Green Juniper	Juniperus chinensis 'Sea Green'	5 Gal.	
	TAY	Taylor Juniper	Juniperus virginiana Taylor	5 Gal.	
	WGB	Winter Green Boxwood	Buxus microphylle 'Winter Green'	B&B	36-48"
	Decidio	ous Shrubs			
	DGW	Variegated Red Twigged Dogwood	Comus alba 'Ivory Halo'	5 Gal.	
_	ESH	Endless Summer Hydrangea	Hydrangea macrophyla 'Balmer'	5 Gal.	
$\circ$	FOR	Lynwood Gold Forsythia	Forsythia x intermedia "Lynwood Gold"	5 Gal.	
9	GLS	Gro-Low Sumac	Rhus Aromatica	5 Gal.	
$\omega$	GMS	Goldmound Spirea	Spiraea japonica 'Goldmound'	5 Gal.	
1)	KNR	Knockout Rose	Rosa knockout	5 Gal.	
-	LHS	Little Henry Sweets pire	tee virginice 'Little Henry'	5 Gel.	
	MCS	Magic Carpet Spirea	Spirea japonica 'Magic Carpet'	2 Gal.	
	QUI	Flowering Quince	Chaenomeles speciosa Texas Scarlet	5 Gal.	
	ROS	Sugar Tip Rose of Sharon/Athea	Hibiscus syriacus 'America Irene Scott'	5 Gal.	
	WIG	Fine Wine Weigela	Weigela forida 'Bramwell'	5 Gal.	
	Grasse	6			
	KEG	Karl Foerster Grass	Calamagrostis x acutifora 'Karl Foerster'	2 Gal.	
~	MLG	Moming Light Maiden Grass	Miscenthus sinensis 'Morning Light'	2 Gal.	
<u>U</u> 3	NWG	Northwind Switch Grass	Panicum virgatum 'Northwind'	2 Gal.	
•	PDS	Prairie Dropseed	Sporobolus heterolepis	2 Gal.	
	VLR	Varioated Lirippe	Liricoe muscari variegata	6" pot	
	Perenn	ials			
	CAT	Cetmint	Nepeta x faassenii 'Walker's Low'	1 Gal.	
	BES	Black-Eved Susan	Rudbeckia fulgida var. Fulgida	1 Gal.	
Op	DAY	Davilly	Hemercallis 'Black Eved Stella' or 'Little Business'	1 Gal.	
8	RS	Blue Fleg Iris	Iris virginica y, shrayei	1 Gal.	
	MSG	Meadow Sage	Salvia nemorosa 'May Knight'	1 Gal.	
	SBA	Summer Beauty Allium	Allum 'Summer Beauty'	1 Gal.	
	SED	Autumn Joy Sedum	Hylotelephium 'Herbstfreude' Autumn Joy	1 Gal.	
	Annuals	5			

EACH BIDDER SHALL VISIT THE SITE OF THE PROPOSED WORK AND EXAMINE THE SITE
CONTINUES. HE SHALL ALSO CAREFULLY EXAMINE THE DRAWINGS FOR THE PROPOSED WORK
AND FAMILIARIZE HIMSELF WITH ALL CONDITIONS, WHICH HAY AFFECT THE PROPOSED WORK.

ON THE PROPOSED WORK.

2. THE PLANTING PLAN GRAPHICALLY ILLUSTRATES OVERALL PLANT MASSINGS. EACH PLANT SPECIES MASSING SHALL BE PLACED IN THE FIELD TO UTILEZ GEALTEST COVERAGE OF GROUND PLANE. THE FOLLOWING APPLIES FOR INDIVIDUAL PLANTINGS:
A CREEPING GROUNDCOVER SHALL BE A MINIMUM OF FROM PAVING EDGE.
B. ALL TREES SHALL BE A INMINIM OF 9 FROM PAVING EDGE.
C. ALL PLANTS OF THE SAME SPECIES SHALL BE EQUALLY SPACED APART AND PLACED FOR BEST ARSTHEID VERWING.

D. ALL SHRUBS SHALL BE A MINIMUM OF 2' FROM PAVED EDGE.

3. NOTIFY LANDSCAPE ARCHITECT 1 WEEK PRIOR TO ANTICIPATED START OF PLANT MATERIAL INSTALLATION. LANDSCAPE CONTRACTOR SHALL STAKE ALL PROPOSED PLANTING BED EDGES. SET OUT SHRUBS IN TEXTEDED LOCATIONS, AND STAKE TREE LOCATIONS FOR APPROVAL BY LANDSCAPE ARCHITECT PRIOR TO INSTALLATION.

4. ALL NEW PLANT BED AREAS TO BE IRRIGATED. REFER TO SPECIFICATIONS FOR IRRIGATION SYSTEM DESCRIPTION.

5. REFER TO L1.00 SERIES SHEETS FOR TREE PLANTINGS.

6. REFER TO L2.00 SERIES SHEETS FOR SHRUB PLANTINGS & ROCK MATERIALS.

7. REFER TO L3.00 SERIES SHEETS FOR PLANTING DETAILS & SPECIFICATIONS.

8. IN THE EVENT OF WORK IN OR ON THE JCW SANITARY MAIN. ANY TREES OR PLANTINGS PLACED WITHIN THE SEWER EASEMENT MAY BE REMOVED WITHOUT REPLACEMENT OR COMPENSATION THERE OF AND SHALL BE REPLACED BY THE PROPERTY OWNER AS REQUIRED BY THE CITY.

9. STRIP TOP SOIL & SAVE FOR PLANTING AREAS. EXCAVATE TO A DEPTH OF 6° FOR ALL PLANTING BEDS AND AMEND WITH PLANTING SOIL MIX. AREAS WITH MORE THAN 16° OF GRAVEL IN PLANT BEDS SHALL BE EXCAVATED TO 16° OR 8° BELOW ROOT BALLS/BOTTOM OF CONTAINER, REFER TO L3.00 FOR PLANTING SOIL MIX.

10. ROCK BEDS SHALL BE BUFFALO RIVER ROCK, 1\*-2.5" SIZE, BY HOUSE OF ROCKS OR APPROVED EQUAL. ALL ROCK BED AREAS SHALL HAVE FILTER FABRIC & BE 4" MIN. DEPTH.

11. ALL LANDSCAPE BEDS WITHIN POOL ENCLOSURE TO INCLUDE RIVER ROCK PER SPECS.

12. FINISHED GRADE TO BE TOP OF MULCH OR TURF FOR ALL LANDSCAPE AREAS. REFER TO

13. ALL LANDSCAPE AREAS NOT IDENTIFIED WITH MULCH, RIVER ROCK, OR OTHER PLANT MATERIAL TO BE SOD. SOD TO EXTEND TO BACK OF CURB FOR ADJACENT PUBLIC STREET.


14. STEPPING STONES SHALL BE HICKORY GREY FLAGSTONE AS PROVIDED BY SEMCO MATERIALS OR APPROVED EQUAL. 24" SQ. MIN. SIZE, 2-3" THICK.

OPPER CREEK
89TH ST. & WOODSONIA RD. LENEXA, KANSAS DEVELOPMENT FOR AT RESERVE THE

final development plan L2.03

JOB NO. 747723 DATE 04.22.24 BH / MM

SHEET NAME SHRUB PLANTING PLAN- DOG PARK SHEET NO.

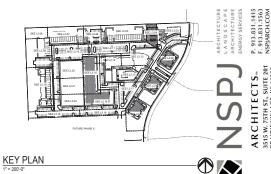

## PLANT LIST

TURF GRASS

Code	Common Name	Botanical Name	Size	Notes
Evergr	een Shrubs			
CGH	China Girl Holly / Boy Holly	llex x meservege 'Mesog' / 'Mesdob'	5 Gal.	5:1 Rati
FCA	Fire Chief Arborytae	Thuja occidentalis 'Congabe'	5 Gal.	
GMC	Gold Mop Cypress	Chamaecyparis pisifera 'Yellow Thread Branch'	5 Gal.	
GOJ	Grey Owl Juniper	Juniperus virginiana 'Grey Owl'	5 Gal.	
HMA	Hetz Midget Arbonvitee	Thuja occidentalis 'Hetz Midget'	5 Gal.	
TMJ	Tam Juniper	Juniperus sabina	5 Gal.	
LLV	Leatherleaf Vibumum	Vibumum rhytidophyllum	5 Gal.	
PFJ	Perfects Juniper	Juniperus chinensis 'Perfecta'	B&B	67 Ht.
SGJ	Sea Green Juniper	Juniperus chinensis 'Sea Green'	5 Gal.	
TAY	Taylor Juniper	Juniperus virginiana Taylor	5 Gal.	
WGB	Winter Green Barwood	Buxus microphylle 'Winter Green'	B&B	36-48
Decidio	ous Shrubs	7.00		
DGW	Variegated Red Twigged Dogwood	Comus alba 'Ivory Halo'	5 Gal.	
ESH	Endless Summer Hydrangea	Hydrangea macrophyla 'Balmer'	5 Gal.	
FOR	Lynwood Gold Forsythia	Forsythia x intermedia "Lynwood Gold"	5 Gal.	
GLS	Gro-Low Sumac	Rhus Aromatica	5 Gal.	
GMS	Goldmound Spirea	Spiraea japonica 'Goldmound'	5 Gal.	
KNR	Knockout Rose	Rosa knockout	5 Gal.	
LHS	Little Henry Sweets pire	Itea virginica 'Little Henry'	5 Gal.	
MCS	Magic Carpet Spirea	Spirea japonica 'Magic Carpet'	2 Gal.	
QUI	Flowering Quince	Chaenomeles speciosa Texas Scarlet	5 Gal.	
ROS	Sugar Tip Rose of Sharon Athea	Hibiscus syriacus 'America Irene Scott'	5 Gal.	
WIG	Fine Wine Weigela	Weigela florida 'Bramwell'	5 Gal.	
Grasse	16			
KFG	Karl Foerster Grass	Calamagrostis x acutiflora 'Karl Foerster'	2 Gal.	
MLG	Moming Light Maiden Grass	Miscenthus sinensis 'Morning Light'	2 Gal.	
NWG	Northwind Switch Grass	Panicum virgatum 'Northwind'	2 Gal.	
PDS	Prairie Dropseed	Sporobolus heterolopis	2 Gal.	
VLR	Varigated Liriope	Liriope muscari variegata	6" pot	
Perent	vials			
CAT	Cetmint	Nepeta x faassenii 'Walker's Low'	1 Gal.	
BES	Black-Eyed Susan	Rudbeckia fulgida var. Fulgida	1 Gal.	
DAY	Daylily	Hemercallis 'Black Eyed Stella' or 'Little Business'	1 Gal.	
RS	Blue Flag Iris	Iris virginica v. shrevei	1 Gal.	
MSG	Meadow Sage	Salvia nemorosa 'May Knight'	1 Gal.	
SBA	Summer Beauty Allium Autumn Joy Sedum	Alium 'Summer Beauty' Hylotelephium 'Herbstfreude' Autumn Joy	1 Gal.	

EACH BIDDER SHALL VISIT THE SITE OF THE PROPOSED WORK AND EXAMINE THE SITE
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AND FAMILIARIZE HIMSELF WITH ALL CONDITIONS, WHICH HAY AFFECT THE PROPOSED WORK.

ON THE PROPOSED WORK.

THE PLANTING PLAN GRAPHICALLY ILLUSTRATES OVERALL PLANT MASSINGS. EACH PLANT SPECIES MASSING SHALL BE PLACED IN THE FIELD TO UTILIZE GREATEST COVERAGE OF GROUND PLANE. THE FOLLOWING APPLIES FOR INDIVIDUAL PLANTINGS:

 A. CREEPING GROUNDCOVER SHALL BE A MINIMUM OF FROM PAVING EDGE.

 B. ALL TREES SHALL BE A MINIMUM OF 3 FROM PAVING EDGE.

 C. ALL PLANTS OF THE SAME SPECIES SHALL BE EQUALLY SPACED APART AND PLACED FOR BEST ASTHETION FROM THE SAME SPECIES SHALL BE AND THE SAME SPECIES SHALL BE AND THE SAME SPECIES SHALL BE EQUALLY SPACED APART AND PLACED FOR BEST ASTHETIO VERWING.

D. ALL SHRUBS SHALL BE A MINIMUM OF 2' FROM PAVED EDGE.

3. NOTIFY LANDSCAPE ARCHITECT 1 WEEK PRIOR TO ANTICIPATED START OF PLANT MATERIAL INSTALLATION. LANDSCAPE CONTRACTOR SHALL STAKE ALL PROPOSED PLANTING BED EDGES. SET OUT SHEWS IN INTENDED LOCATIONS, AND STAKE TREE LOCATIONS FOR APPROVAL BY LANDSCAPE ARCHITECT PRIOR TO INSTALLATION.

4. ALL NEW PLANT BED AREAS TO BE IRRIGATED. REFER TO SPECIFICATIONS FOR IRRIGATION SYSTEM DESCRIPTION.

5. REFER TO L1.00 SERIES SHEETS FOR TREE PLANTINGS.

6. REFER TO L2.00 SERIES SHEETS FOR SHRUB PLANTINGS & ROCK MATERIALS.

7. REFER TO L3.00 SERIES SHEETS FOR PLANTING DETAILS & SPECIFICATIONS.

8. IN THE EVENT OF WORK IN OR ON THE JCW SANITARY MAIN. ANY TREES OR PLANTINGS PLACED WITHIN THE SEWER EASEMENT MAY BE REMOVED WITHOUT REPLACEMENT OR COMPENSATION THERE OF AND SHALL BE REPLACED BY THE PROPERTY OWNER AS REQUIRED BY THE CITY.

9. STRIP TOP SOIL & SAVE FOR PLANTING AREAS. EXCAVATE TO A DEPTH OF 6° FOR ALL PLANTING BEDS AND AMEND WITH PLANTING SOIL MIX. AREAS WITH MORE THAN 16° OF GRAVEL IN PLANT BEDS SHALL BE EXCAVATED TO 16° OR 8° BELOW ROOT BALLS/BOTTOM OF CONTAINER, REFER TO L3.00 FOR PLANTING SOIL MIX.

10. ROCK BEDS SHALL BE BUFFALO RIVER ROCK, 1"-2.5" SIZE, BY HOUSE OF ROCKS OR APPROVED EQUAL. ALL ROCK BED AREAS SHALL HAVE FILTER FABRIC & BE 4" MIN. DEPTH.

11. ALL LANDSCAPE BEDS WITHIN POOL ENCLOSURE TO INCLUDE RIVER ROCK PER SPECS.

12. FINISHED GRADE TO BE TOP OF MULCH OR TURF FOR ALL LANDSCAPE AREAS. REFER TO CIVIL PLANS FOR GRADING INFORMATION.

13. ALL LANDSCAPE AREAS NOT IDENTIFIED WITH MULCH, RIVER ROCK, OR OTHER PLANT MATERIAL TO BE SOD. SOD TO EXTEND TO BACK OF CURB FOR ADJACENT PUBLIC STREET.

14. STEPPING STONES SHALL BE HICKORY GREY FLAGSTONE AS PROVIDED BY SEMCO MATERIALS OR APPROVED EQUAL. 24" SQ. MIN. SIZE, 2-3" THICK.

JOB NO. 747723 BH / MM

SHEET NAME SHRUB PLANTING PLAN- PARKING AREA

OPPER CREEK
89TH ST. & WOODSONIA RD. LENEXA, KANSAS RESERVE AT

MULTIFAMILY DEVELOPMENT FOR THE

DATE 04.22.24

final development plan L2.04

- EACH BIDDER SHALL VISIT THE SITE OF THE PROPOSED WORK AND EXAMINE THE SITE CONDITIONS. HE SHALL ALSO CAREFULLY EXAMINE THE DRAWINGS FOR THE PROPOSED WORK AND FAMILIARIZE HIMSELF WITH ALL CONDITIONS, WHICH MAY AFFECT THE PROPOSED WORK.
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  A. CREEPING GROUNDCOVER SHALL BE A MINIMUM OF FFROM PAVING EDGE.


  C. ALL PLANTS OF THE SAME SPECIES SHALL BE COULD'S PAPACED APART AND PLACED FOR BEST ASSINETIO WIEWING.

  D. ALL SPRINGS SHALL BE A MINIMUM OF 2 FROM PAVED EDGE.


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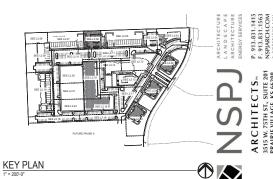
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- 9 STRIP TOP SOIL & SAVE FOR PLANTING AREAS. EXCAVATE TO A DEPTH OF 6" FOR ALL PLANTING BEDS AND AMEND WITH PLANTING SOIL MIX. AREAS WITH MORE THAN 18" OF GRAVEL IN PLANT BEDS SHALL BE EXCAVATED TO 18" OR 8" BELOW ROOT BALLS/BOTTOM OF CONTAINER REFER TO L3.00 FOR PLANTING SOIL MIX
- 10. ROCK BEDS SHALL BE BLIEFALO RIVER ROCK 1"-2 5" SIZE BY HOUSE OF ROCKS OR ROVED EQUAL. ALL ROCK BED AREAS SHALL HAVE FILTER FABRIC & BE 4" MIN. DEPTH
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Code	Common Name	Botanical Name	Size	Notes
Evergr	een Shrubs			
CGH	China Girl Holly / Boy Holly	lex x meserveae 'Mesog' / 'Mesdob'	5 Gal.	5:1 Ratio
FCA	Fire Chief Arborytae	Thuja occidentalis 'Congabe'	5 Gal.	
GMC	Gold Mop Cypress	Chamaecyparis pisifera "Yellow Thread Branch"	5 Gal.	
GOJ	Grey Owl Juniper	Juniperus virginiana 'Grey Owl'	5 Gal.	
HMA	Hetz Midget Arborvitae	Thuja occidentalis "Hetz Midget"	5 Gal.	
TMJ	Tam Juniper	Juniperus sabina	5 Gal.	
LLV	Leatherleaf Viburnum	Viburnum rhytidophylum	5 Gal.	
PFJ	Perfects Juniper	Juniperus chinens is 'Perfecta'	B&B	6" Ht.
SGJ	Sea Green Juniper	Juniperus chinens is 'Sea Green'	5 Gal.	
TAY	Taylor Juniper	Juniperus virginiana 'Taylor'	5 Gal	
WGB	Winter Green Boxwood	Buxus microphylla 'Winter Green'	B&B	36-48*
Decidio	ous Shrubs			
DGW	Variegated Red Twigged Dogwood	Comus alba 'Wory Halo'	5 Gal.	
ESH	Endless Summer Hydrangea	Hydrangea macrophylia 'Bailmer'	5 Gal	_
FOR	Lynwood Gold Forsythia	Fors Whia x informedia "L vow ood Gold"	5 Gal.	
GLS	Gro-Low Sumac	Rhus Aromatica	5 Gal.	
GMS	Goldmound Spirea	Spiraea japonica 'Goldmound'	5 Gal.	_
KNR	Knockout Rose	Rosa knockout	5 Gal	_
LHS	Little Henry Sweetspire	tea virginica 'Little Henry'	5 Gal	_
MCS	Magic Carpet Spirea	Spirea japonica 'Magic Carpet'	2 Gal.	-
QUI	Flowering Quince	Chaenomeles speciosa 'Texas Scarlet'	5 Gal	_
ROS	Sugar Tip Rose of Sharon/Athea	Hibiscus syriacus 'America Irene Scoti'	5 Gal	_
WIG	Fine Wine Weigele	Weigela florida 'Bramwell'	5 Gal.	_
Grasse		Troughas annual Branches		
KEG.	Karl Foerster Grass	Calamacrostis x acutiflora 'Karl Foerster'	2 Gal.	1
MIG	Morning Light Maiden Grass	Miscanthus sinensis "Morning Light"	2 Gal	_
NWG	Northwind Switch Grass	Penicum virgetum Northwind	2 Gal.	
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VIR	Varigated Lirippe	Liriope muscari variegata	6" pot	_
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DAY	Dayliy	Hemercallis 'Black Eved Stella' or 'Little Business'	1 Gal.	_
RS	Blue Flag kis	Iris virginica v. shrevei	1 Gal	_
MSG	Meadow Sage	Salvia nemorosa "May Knight"	1 Gal.	_
SBA	Summer Beauty Alium	Alium 'Summer Beauty'	1 Gal	



- BUILDING #6-N

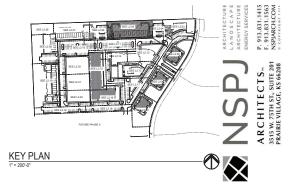

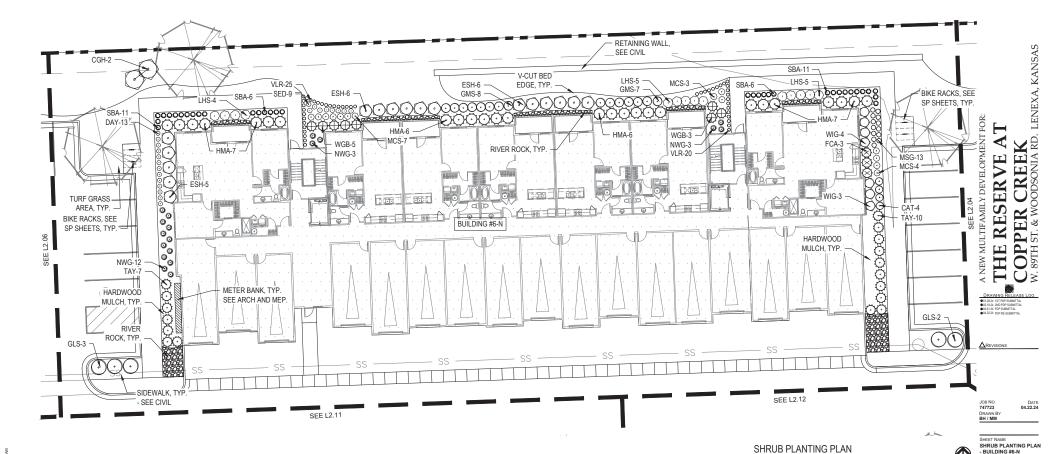

PLANT LIST

	Code	Common Name	Botanical Name	Size	Notes
	Evergr	een Shrubs			
	CGH	China Girl Holly / Boy Holly	llex x meserveae 'Mesog' / 'Mesdob'	5 Gal.	5:1 Ratio
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**	GMC	Gold Mop Cypress	Chamaecyparis pisifera 'Yellow Thread Branch'	5 Gal.	
₩2	GOJ	Grey Owl Juniper	Juniperus virginiana 'Grey Owl'	5 Gal.	
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Ø~	TMJ	Tam Juniper	Juniperus sabina	5 Gal.	
	LLV	Leatherleaf Vibumum	Vibumum rhytidophyllum	5 Gal.	
	PFJ	Perfects Juniper	Juniperus chinensis 'Perfecta'	B&B	67 Ht.
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	WGB	Winter Green Boxwood	Buxus microphylle 'Winter Green'	B&B	36-48"
	Decidlo	ous Shrubs	7.07		
	DGW	Variegated Red Twigged Dogwood	Comus alba 'Ivory Halo'	5 Gal.	
	ESH	Endless Summer Hydrangea	Hydrangea macrophyla 'Balmer'	5 Gal.	
•	FOR	Lynwood Gold Forsythia	Forsythia x intermedia 'Lynwcod Gold'	5 Gal.	
<b>1</b>	GLS	Gro-Low Sumac	Rhus Aromatica	5 Gal.	
$\approx$	GMS	Goldmound Spirea	Spiraea japonica 'Goldmound'	5 Gal.	
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	QUI	Flowering Quince	Chaenomeles speciosa Texas Scarlet	5 Gal.	
	ROS	Sugar Tip Rose of Sharon/Athea	Hibiscus syriacus 'America Irene Scott'	5 Gal.	
	WIG	Fine Wine Weigela	Weigela florida 'Bramwell'	5 Gal.	
	Grasse	16			
	KFG	Karl Foerster Grass	Calamagrostis x acutiflora 'Karl Foerster'	2 Gal.	
	MLG	Moming Light Maiden Grass	Miscenthus sinensis 'Morning Light'	2 Gal.	
3	NWG	Northwind Switch Grass	Panicum virgatum 'Northwind'	2 Gal.	
,	PDS	Prairie Dropseed	Sporobolus heterolopis	2 Gal.	
	VLR	Varigated Liriope	Liriope muscari variegata	6" pct	
	Perenr				
	CAT	Catmint	Nepeta x faassenii 'Walker's Low'	1 Gal.	
	BES	Black-Eyed Susan	Rudbeckia fulgida var. Fulgida	1 Gal.	
OP	DAY	Daylily	Hemercallis 'Black Eyed Stella' or 'Little Business'	1 Gal.	
8	RS	Blue Flag Iris	Iris virginica v. shrevei	1 Gal.	
-	MSG	Meadow Sage	Salvia nemorosa 'May Knight'	1 Gal.	
	SBA	Summer Beauty Allium	Allum 'Summer Beauty'	1 Gal.	
	SED	Autumn Joy Sedum	Hytotelenhium 'Herhstfreude' Autumn Joy	1 Gal	

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 A. CREEPING GROUNDCOVER SHALL BE A MINIMUM OF FROM PAVING EDGE.

 B. ALL TREES SHALL BE A MINIMUM OF 3 FROM PAVING EDGE.

 C. ALL PLANTS OF THE SAME SPECIES SHALL BE EQUALLY SPACED APART AND PLACED FOR BEST ASTHETION FROM THE SAME SPECIES SHALL BE AND THE SAME SPECIES SHALL BE AND THE SAME SPECIES SHALL BE EQUALLY SPACED APART AND PLACED FOR BEST ASTHETIO VERWING.

D. ALL SHRUBS SHALL BE A MINIMUM OF 2' FROM PAVED EDGE.

3. NOTIFY LANDSCAPE ARCHITECT 1 WEEK PRIOR TO ANTICIPATED START OF PLANT MATERIAL INSTALLATION. LANDSCAPE CONTRACTOR SHALL STAKE ALL PROPOSED PLANTING BED EDGES. SET OUT SHEWS IN INTENDED LOCATIONS, AND STAKE TREE LOCATIONS FOR APPROVAL BY LANDSCAPE ARCHITECT PRIOR TO INSTALLATION.

4. ALL NEW PLANT BED AREAS TO BE IRRIGATED. REFER TO SPECIFICATIONS FOR IRRIGATION SYSTEM DESCRIPTION.

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9. STRIP TOP SOIL & SAVE FOR PLANTING AREAS. EXCAVATE TO A DEPTH OF 6" FOR ALL PLANTING BEDS AND AMEND WITH PLANTING SOIL MIX. AREAS WITH MORE THAN 16" OF GRAVEL IN PLANT BEDS SHALL BE EXCAVATED 10 16" OR 8" BELOW ROOT BALLS/BOTTOM OF CONTAINER, REFER TO L3.00 FOR PLANTING SOIL MIX.

10. ROCK BEDS SHALL BE BUFFALO RIVER ROCK, 1\*-2.5" SIZE, BY HOUSE OF ROCKS OR APPROVED EQUAL. ALL ROCK BED AREAS SHALL HAVE FILTER FABRIC & BE 4" MIN. DEPTH.

11. ALL LANDSCAPE BEDS WITHIN POOL ENCLOSURE TO INCLUDE RIVER ROCK PER SPECS.

12. FINISHED GRADE TO BE TOP OF MULCH OR TURF FOR ALL LANDSCAPE AREAS. REFER TO CIVIL PLANS FOR GRADING INFORMATION.

13. ALL LANDSCAPE AREAS NOT IDENTIFIED WITH MULCH, RIVER ROCK, OR OTHER PLANT MATERIAL TO BE SOD. SOD TO EXTEND TO BACK OF CURB FOR ADJACENT PUBLIC STREET.

14. STEPPING STONES SHALL BE HICKORY GREY FLAGSTONE AS PROVIDED BY SEMCO MATERIALS OR APPROVED EQUAL. 24" SQ. MIN. SIZE, 2-3" THICK.

BH / MM

DATE 04.22.24

SHEET NAME SHRUB PLANTING PLAN - PARKING AREA FINAL DEVELOPMENT PLAN

FINAL

JOB NO. 747723

OPPER CREEK
89TH ST. & WOODSONIA RD. LENEXA, KANSAS RESERVE AT THE

MULTIFAMILY DEVELOPMENT FOR

- EACH BIDDER SHALL VISIT THE SITE OF THE PROPOSED WORK AND EXAMINE THE SITE CONDITIONS. HE SHALL ALSO CAREFULLY EXAMINE THE DRAWINGS FOR THE PROPOSED WORK AND FAMILIARIZE HIMSELF WITH ALL CONDITIONS, WHICH MAY AFFECT THE PROPOSED WORK.
- 2. THE PLANTING PLAN GRAPHICALLY ILLUSTRATES OVERALL PLANT MASSINGS. EACH PLANT SPECIES MASSING SHALL BE PLACED IN THE FIELD TO UTILIZE GREATEST COVERAGE OF OWNER OF THE PLANT OF THE PLANT OF THE ADMINIST EDGE.

  A. CREEPING GROUNDCOVER SHALL BE A MINIMUM OF FFROM PAVING EDGE.

  C. ALL PLANTS OF THE SAME SPECIES SHALL BE COULD'S PAPACED APART AND PLACED FOR BEST ASSINETIO WIEWING.


  D. ALL SPRINGS SHALL BE A MINIMUM OF 2 FROM PAVED EDGE.


- NOTIFY LANDSCAPE ARCHITECT 1 WEEK PRIOR TO ANTICIPATED START OF PLANT MATERIAL INSTALLATION. LANDSCAPE CONTRACTOR SHALL STAKE ALL PROPOSED PLANTING BED EDGES, SET OUT SHRIBES IN INTENDED LOCATIONS, AND STAKE TREE LOCATIONS FOR APPROVAL BY LANDSCAPE ARCHITECT PRIOR TO INSTALLATION.
- 4. ALL NEW PLANT BED AREAS TO BE IRRIGATED. REFER TO SPECIFICATIONS FOR IRRIGATION SYSTEM DESCRIPTION.
- 5. REFER TO L1.00 SERIES SHEETS FOR TREE PLANTINGS.
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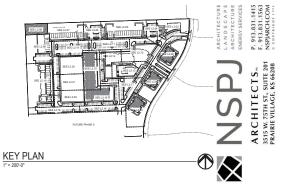
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  D. ALL SHRUSS SHALL BE A MINIMUM OF 2' FROM PAVED EDGE.


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Code	Common Name	Botanical Name	Size	Notes
Everg	een Shrubs			
CGH	China Girl Holly / Boy Holly	lex x meserveae 'Mesog' / 'Mesdob'	5 Gal.	5:1 Ratio
FCA	Fire Chief Arborvitee	Thuja occidentalis 'Congabe'	5 Gal.	
GMC	Gold Mop Cypress	Chamaecyparis pisifera "Yellow Thread Branch"	5 Gal.	
GOJ	Grey Owl Juniper	Juniperus virginiana 'Grey Owl'	5 Gal.	
HMA	Hetz Midget Arborvitae	Thuja occidentalis "Hetz Midget"	5 Gal.	
TMJ	Tam Juniper	Juniperus sabina	5 Gal.	
LLV	Leatherleaf Viburnum	Viburnum rhytidophyllum	5 Gal.	
PFJ	Perfects Juniper	Juniperus chinens is 'Perfecta'	B&B	6" Ht.
SGJ	Sea Green Juniper	Juniperus chinensis 'Sea Green'	5 Gal.	
TAY	Taylor Juniper	Juniperus virginiana 'Taylor'	5 Gal.	
WGB	Winter Green Boxwood	Buxus microphylla 'Winter Green'	B&B	36-48"
Decidi	ous Shrubs			
DGW	Variegated Red Twigged Dogwood	Comus alba 'wory Halo'	5 Gal.	
ESH	Endless Summer Hydrangea	Hydrangea macrophylia 'Bailmer'	5 Gal.	
FOR	Lynwood Gold Forsythia	Fors ythia x intermedia "Lynwood Gold"	5 Gal.	
GLS	Gro-Low Sumac	Rhus Aromatica	5 Gal.	
GMS	Goldmound Spirea	Spiraea japonica 'Goldmound'	5 Gal.	
KNR	Knockout Rose	Rosa knockout	5 Gal.	
LHS	Little Henry Sweetspire	tea virginica 'Little Henry'	5 Gal.	
MCS	Magic Carpet Spirea	Spirea japonica 'Magic Carpet'	2 Gal.	
QUI	Flowering Quince	Chaenomeles speciosa 'Texas Scarlet'	5 Gal.	
ROS	Sugar Tip Rose of Sharon/Athea	Hibiscus swiacus 'America Irene Scoti'	5 Gal.	
WIG	Fine Wine Weigela	Weixela florida 'Bramwell'	5 Gal.	
Grasse	16			
KEG	Karl Foerster Grass	Calamacrostis x acutiflora 'Karl Foerster'	2 Gal.	T
MLG	Morning Light Maiden Grass	Miscenthus sinensis "Morning Light"	2 Gal.	
NWG	Northwind Switch Grass	Penicum virgetum 'Northwind'	2 Gal.	
PDS	Prairie Dropseed	Sporobolus heterolepis	2 Gal.	
VLR	Varigated Lirippe	Liricoe muscari variegata	6" pot	
Perent	vials			
CAT	Catmint	Nepeta x faassenii 'Walker's Low'	1 Gal.	T
BES	Black-Eved Susan	Rudbeckia fulgida var. Fulgida	1 Gal.	_
DAY	Davliy	Hemercallis 'Black Eyed Stella' or 'Little Business'	1 Gal.	
RS	Blue Fleg Iris	Iris virginica v. shrevei	1 Gal.	_
MSG	Meadow Sage	Salvia nemorosa 'May Knight'	1 Gal.	
SBA	Summer Beauty Allium	Alium 'Summer Beauty'	1 Gal	
SED	Autumn Joy Sedum	Hylotelephium 'Herbstfreude' Autumn Joy	1 Gal.	_


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OPPER CREEK 89TH ST. & WOODSONIA RD. LENEXA, KANSAS NEW MULTIFAMILY DEVELOPMENT FOR: THE RESERVE AT JOB NO. 747723 DATE 04.22.24

DRAWN BY BH / MM

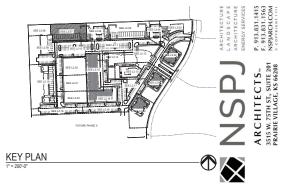

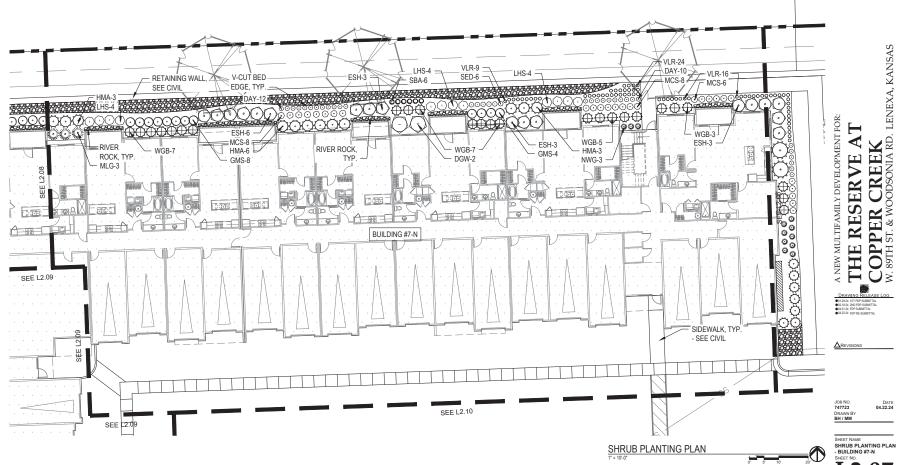
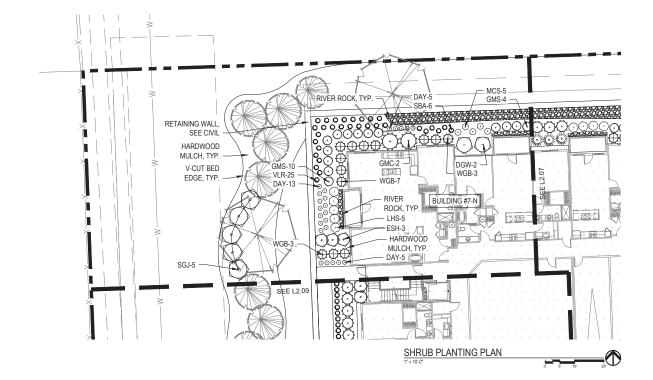
## PLANT LIST

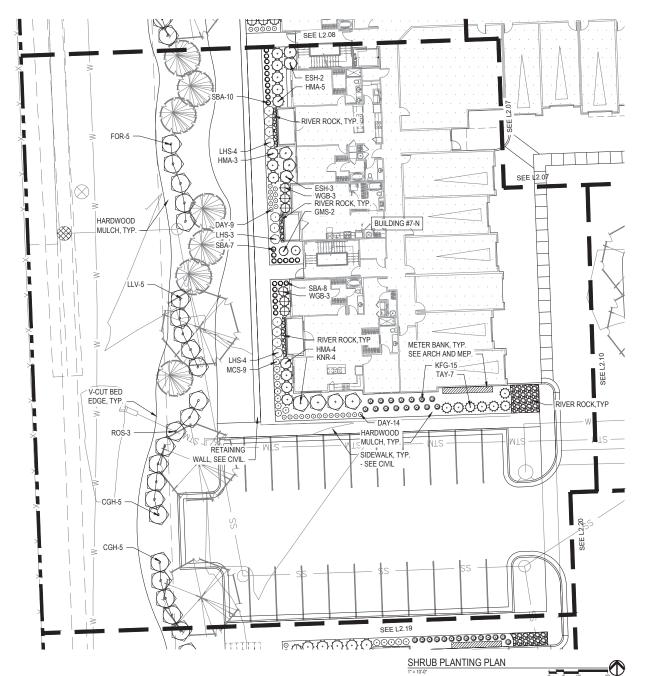Code	Common Name	Botanical Name	Size	Notes
Evergr	een Shrubs			
CGH	China Girl Holly / Boy Holly	llex x meserveae 'Mesog' / 'Mesdob'	5 Gal.	5:1 Ratio
FCA	Fire Chief Arborvitee	Thuja occidentalis 'Congabe'	5 Gal.	
GMC	Gold Mop Cypress	Chamaecyparis pisifera 'Yellow Thread Branch'	5 Gal.	
GOJ	Grey Owl Juniper	Juniperus virginiana 'Grey Owl'	5 Gal.	
HMA	Hetz Midget Arborvitee	Thuja occidentalis 'Hetz Midget'	5 Gal.	
TMJ	Tam Juniper	Juniperus sabina	5 Gal.	
LLV	Leatherleaf Vibumum	Vibumum rhytidophyllum	5 Gal.	
PFJ	Perfects Juniper	Juniperus chinensis 'Perfecta'	B&B	67 Ht.
SGJ	Sea Green Juniper	Juniperus chinensis 'Sea Green'	5 Gal.	
TAY	Taylor Juniper	Juniperus virginiana Taylor	5 Gal.	
WGB	Winter Green Boxwood	Buxus microphylle 'Winter Green'	B&B	36-48"
Decidio	ous Shrubs			
DGW	Variegated Red Twigged Dogwood	Comus alba 'Ivory Halo'	5 Gal.	
ESH	Endless Summer Hydrangea	Hydrangea macrophyla 'Balmer'	5 Gal.	
FOR	Lynwood Gold Forsythia	Forsythia x intermedia 'Lynwood Gold'	5 Gal.	
GLS	Gro-Low Sumac	Rhus Aromatica	5 Gal.	
GMS	Goldmound Spirea	Spiraea japonica 'Goldmound'	5 Gal.	
KNR	Knockout Rose	Rosa knockout	5 Gal.	
LHS	Little Henry Sweets pire	Itea virginica 'Little Henry'	5 Gel.	
MCS	Magic Carpet Spirea	Spirea japonica 'Magic Carpet'	2 Gal.	
QUI	Flowering Quince	Chaenomeles speciosa Texas Scarier	5 Gal.	
ROS	Sugar Tip Rose of Sharon/Athea	Hibiscus syriacus 'America Irene Scott'	5 Gal.	
WIG	Fine Wine Weigela	Weigela forida 'Bramwell'	5 Gal.	
Grasse	6			
KEG	Karl Foerster Grass	Calamagrostis x acutifora 'Karl Foerster'	2 Gal.	
MLG	Moming Light Maiden Grass	Miscenthus sinensis 'Morning Light'	2 Gal.	
NWG	Northwind Switch Grass	Panicum virgatum 'Northwind'	2 Gal.	
PDS	Prairie Dropseed	Sporobolus heterolepis	2 Gal.	
VLR	Varioated Lirippe	Liricoe muscari variegata	6" pot	
Perent	ials			
CAT	Cetmint	Nepeta x faassenii 'Walker's Low'	1 Gal.	
BES	Black-Eved Susan	Rudbeckia fulgida var. Fulgida	1 Gal.	
DAY	Davilly	Hemercalis 'Black Eyed Stella' or 'Little Business'	1 Gal.	
RS	Blue Flag Iris	Iris virginica v. shrayei	1 Gal.	
MSG	Meadow Sage	Salvia nemorosa 'May Knight'	1 Gal.	
SBA	Summer Beauty Allium	Allum 'Summer Beauty'	1 Gal.	
SED	Autumn Joy Sedum	Hyfotelephium 'Herbstfreude' Autumn Joy	1 Gal.	

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A CREEPING GROUNDCOVER SHALL BE A MINIMUM OF 9 FROM PAVING EDGE.
B. ALL TREES SHALL BE A MINIMUM OF 9 FROM PAVING EDGE.
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D. ALL SHRUBS SHALL BE A MINIMUM OF 2' FROM PAVED EDGE.

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OPPER CREEK
89TH ST. & WOODSONIA RD. LENEXA, KANSAS DEVELOPMENT FOR RESERVE AT THE

JOB NO. 747723

DATE 04.22.24 BH / MM

SHEET NAME SHRUB PLANTING PLAN - BUILDING #7-N


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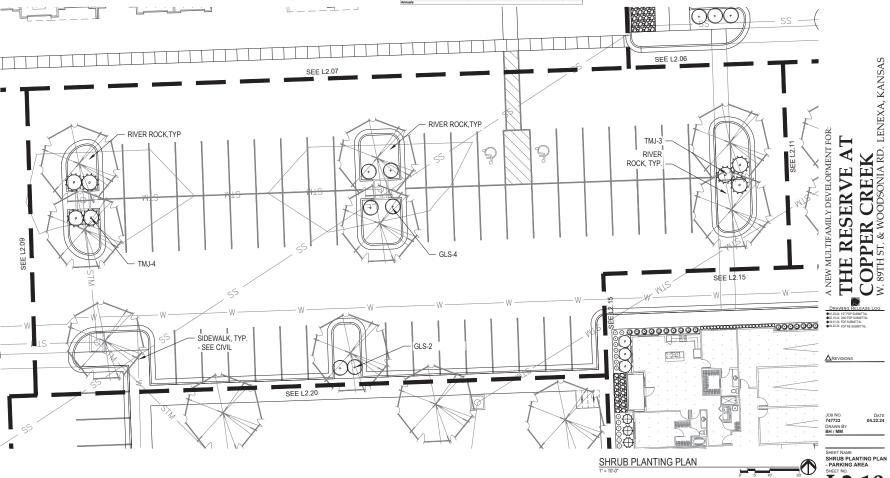
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FINAL DEVELOPMENT PLAN



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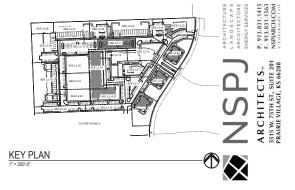
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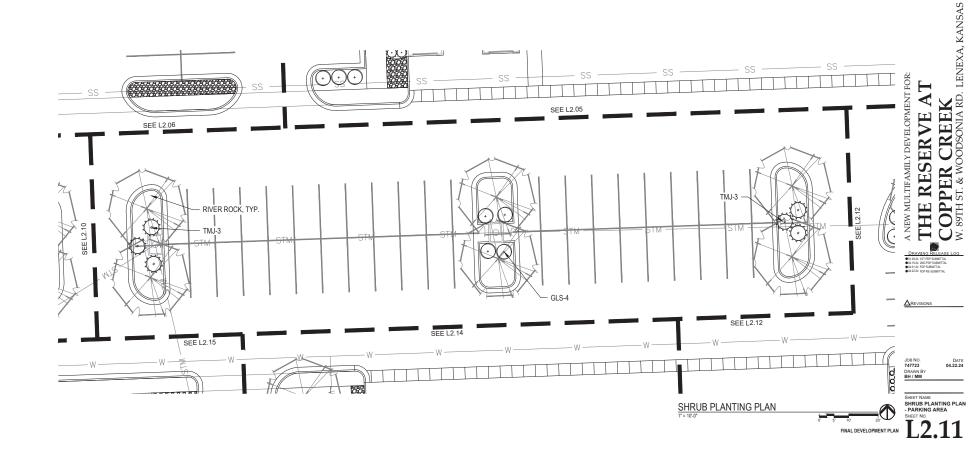
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Decidio	ous Shrubs			
DGW	Variegated Red Twigged Dogwood	Comus alba 'vory Halo'	5 Gal.	-
ESH	Endless Summer Hydrangea	Hydrangea macrophylia 'Bailmer'	5 Gal.	-
FOR	Lynwood Gold Forsythia	Fors Whia x informedia "L vow ood Gold"	5 Gal.	_
GLS	Gro-Low Sumac	Rhus Aromatica	5 Gal	-
GMS	Goldmound Spirea	Spiraea japonica 'Goldmound'	5 Gal.	-
KNR	Knockout Rose	Rosa knockout	5 Gal	-
LHS	Little Henry Sweetspire	tea virginica 'Little Henry'	5 Gal.	-
MCS	Magic Carpet Spirea	Spirea japonica 'Magic Carpet'	2 Gal.	-
QUI	Flowering Quince	Chaenomeles speciosa 'Texas Scarlet'	5 Gal.	-
ROS	Sugar Tip Rose of Sharon/Athea	Hibiscus swiacus 'America Irene Scoti'	5 Gal	-
WIG	Fine Wine Weigele	Weigela florida 'Bramwell'	5 Gal.	-
Grasse	15			
KEG	Karl Foerster Grass	Calamagrostis x acutiflora 'Karl Foerster'	2 Gal.	
MLG	Morning Light Maiden Grass	Miscenthus sinensis "Morning Light"	2 Gal	-
NWG	Northwind Switch Grass	Penicum virgetum Northwind	2 Gal.	_
PDS	Prairie Dropseed	Sporobolus heterolepis	2 Gal.	-
VLR	Varigated Liriope	Liriope muscari variegata	6" pot	_
Perent	vials			
CAT	Cetroint	Nepeta x faassenii 'Walker's Low'	1 Gal.	_
BES	Black-Eved Susan	Rudbeckia fulgida var. Fulgida	1 Gal.	-
DAY	Davliv	Hemercallis 'Black Eyed Stella' or 'Little Business'	1 Gal.	+
RS	Blue Fleg Iris	Iris virginica v. shrevei	1 Gal.	-
MSG	Meadow Sage	Salvia nemorosa 'May Knight'	1 Gal.	-
SBA	Summer Beauty Alium	Alium 'Summer Beauty'	1 Gal	
SED	Autumn Joy Sedum	Hylotelephium 'Herbstfreude' Autumn Joy	1 Gal.	+

DI ANTLICT



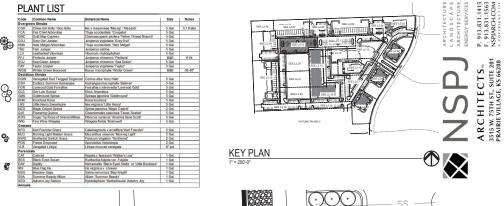

- EACH BIDDER SHALL VISIT THE SITE OF THE PROPOSED WORK AND EXAMINE THE SITE CONDITIONS. HE SHALL ALSO CAREFULLY EXAMINE THE DRAWINGS FOR THE PROPOSED WORK AND FAMILIARIZE HIMSELF WITH ALL CONDITIONS, WHICH MAY AFFECT THE PROPOSED WORK.
- 2. THE PLANTING PLAN GRAPHICALLY ILLUSTRATES OVERALL PLANT MASSINGS. EACH PLANT SPECIES MASSING SHALL BE PLACED IN THE FIELD TO UTILIZE GREATEST COVERAGE OF OWNER OF THE PLANT OF THE PLANT OF THE ADMINIST EDGE.

  A. CREEPING GROUNDCOVER SHALL BE A MINIMUM OF FFROM PAVING EDGE.

  C. ALL PLANTS OF THE SAME SPECIES SHALL BE COULD'S PAPACED APART AND PLACED FOR BEST ASSINETIO WIEWING.

  D. ALL SPRINGS SHALL BE A MINIMUM OF 2 FROM PAVED EDGE.


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- 4. ALL NEW PLANT BED AREAS TO BE IRRIGATED. REFER TO SPECIFICATIONS FOR IRRIGATION SYSTEM DESCRIPTION.
- 5. REFER TO L1.00 SERIES SHEETS FOR TREE PLANTINGS.
- 6. REFER TO L2.00 SERIES SHEETS FOR SHRUB PLANTINGS & ROCK MATERIALS.
- 7. REFER TO L3.00 SERIES SHEETS FOR PLANTING DETAILS & SPECIFICATIONS

- 8. IN THE EVENT OF WORK IN OR ON THE JCW SANITARY MAIN. ANY TREES OR PLANTINGS PLACED WITHIN THE SEWER EASEMENT MAY BE REMOVED WITHOUT REPLACEMENT OR COMPENSATION THERE OF AND SHALL BE REPLACED BY THE PROPERTY OWNER AS REQUIRED BY THE CITY.
- STRIP TOP SOIL & SAVE FOR PLANTING AREAS. EXCAVATE TO A DEPTH OF 6° FOR ALL PLANTING BEDS AND AMEND WITH PLANTING SOIL MIX. AREAS WITH MORE THAN 18° OF GRAVEL IN PLANT BEDS SHALL BE EXCAVATED 10 16° OR 8° BELOW ROOT BALLS/BOTTOM OF CONTAINER, REFER TO L3.00 FOR PLANTING SOIL MIX.
- 10. ROCK BEDS SHALL BE BUFFALO RIVER ROCK, 1"-2.5" SIZE, BY HOUSE OF ROCKS OR APPROVED EQUAL. ALL ROCK BED AREAS SHALL HAVE FILTER FABRIC & BE 4" MIN. DEPTH.
- 11. ALL LANDSCAPE BEDS WITHIN POOL ENCLOSURE TO INCLUDE RIVER ROCK PER SPECS.
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- 13. ALL LANDSCAPE AREAS NOT IDENTIFIED WITH MULCH, RIVER ROCK, OR OTHER PLANT MATERIAL TO BE SOD. SOD TO EXTEND TO BACK OF CURB FOR ADJACENT PUBLIC STREET.

GLS-10

SEE L2.05

14. STEPPING STONES SHALL BE HICKORY GREY FLAGSTONE AS PROVIDED BY SEMCO MATERIALS OR APPROVED EQUAL. 24" SQ. MIN. SIZE, 2-3" THICK.

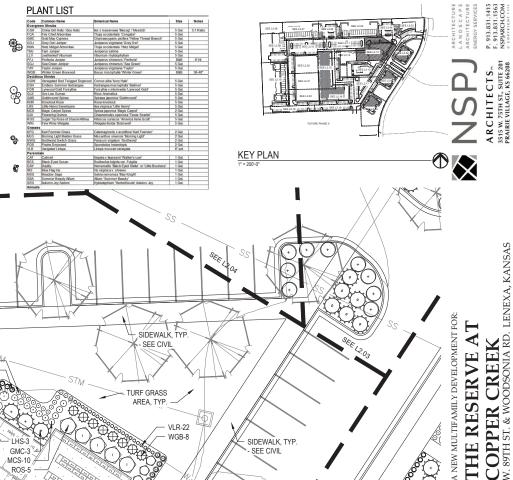


SHRUB PLANTING PLAN

JOB NO. 747723

FINAL DEVELOPMENT PLAN

SHEET NAME
SHRUB PLANTING PLAN
- BUILDING #4-N (CLUB)
SHEET NO.

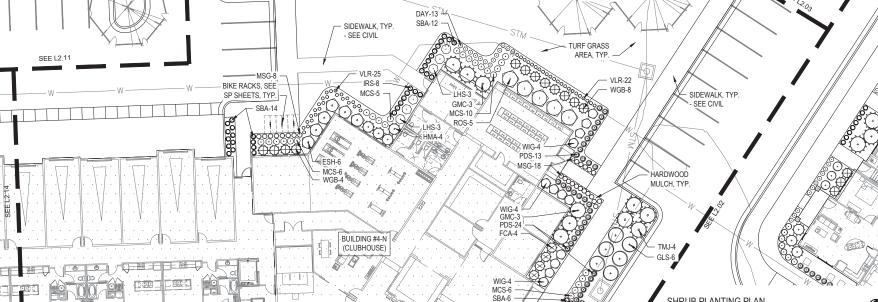



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- 2. THE PLANTING PLAN GRAPHICALLY ILLUSTRATES OVERALL PLANT MASSINGS. EACH PLANT PECCES MASSING SHALL BE PLACED IN THE FIELD TO UTILIZE GREATEST COVERAGE OF REAL PLANT PLAN

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- 4. ALL NEW PLANT BED AREAS TO BE IRRIGATED. REFER TO SPECIFICATIONS FOR IRRIGATION SYSTEM DESCRIPTION.
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- 10. ROCK BEDS SHALL BE BUFFALO RIVER ROCK, 1"-2.5" SIZE, BY HOUSE OF ROCKS OR APPROVED EQUAL. ALL ROCK BED AREAS SHALL HAVE FILTER FABRIC & BE 4" MIN. DEPTH.
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- 13. ALL LANDSCAPE AREAS NOT IDENTIFIED WITH MULCH, RIVER ROCK, OR OTHER PLANT MATERIAL TO BE SOD. SOD TO EXTEND TO BACK OF CURB FOR ADJACENT PUBLIC STREET.
- 14. STEPPING STONES SHALL BE HICKORY GREY FLAGSTONE AS PROVIDED BY SEMCO MATERIALS OR APPROVED EQUAL. 24" SQ. MIN. SIZE, 2-3" THICK





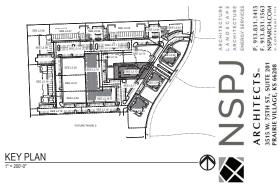

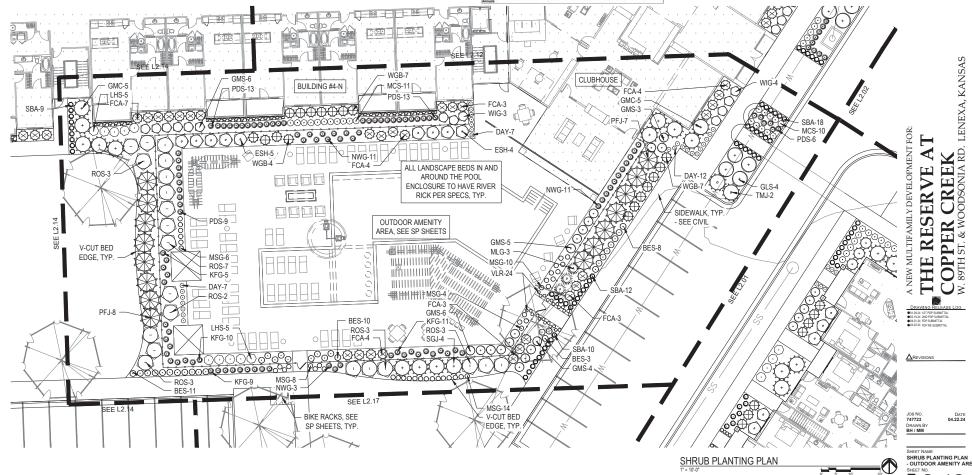FINAL DEVELOPMENT PLAN

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  A CHEEPING GROUNDCOVER SHALL BE A MINIMUM OF FIRM SHOW SHING EDGE.
  C. ALI PLANTS OF THE SAME SPECIES SHALL BE COULTLY SPACED APART AND PLACED FOR BEST ASSTHERD VIEWING.
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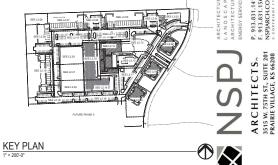
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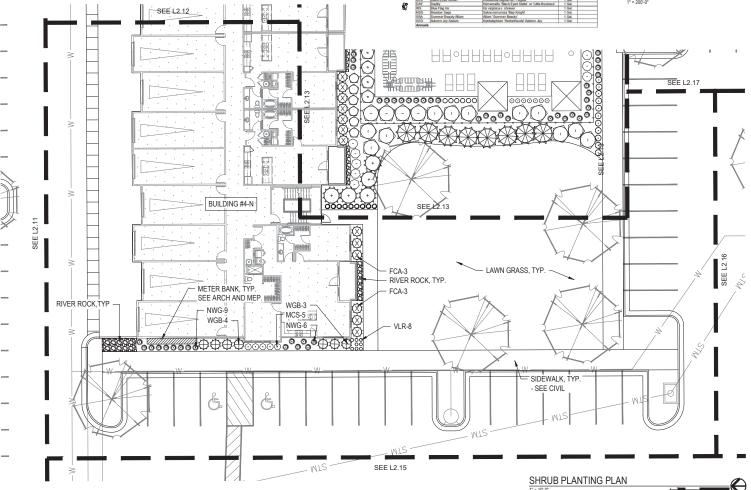


Size Notes 5:1 Ratio

6" Ht.

PLANT LIST





OPPER CREEK 89TH ST. & WOODSONIA RD. LENEXA, KANSAS NEW MULTIFAMILY DEVELOPMENT FOR THE RESERVE AT

JOB NO. 747723 DRAWN BY BH / MM

SHEET NAME SHRUB PLANTING PLAN - BUILDING #4-N

FINAL DEVELOPMENT PLAN


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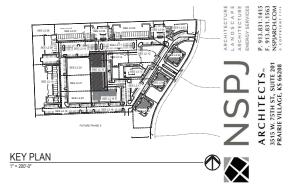
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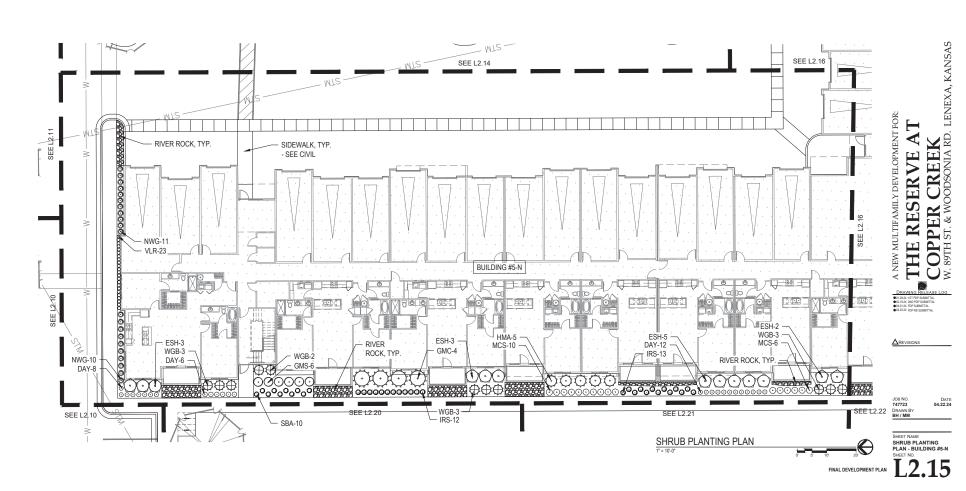
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SEE L2.21

SBA-7

MSG-12

公自

RIVER ROCK, TYP.

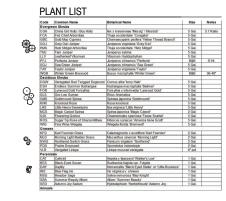IRS-6

GMS-4 - HMA-5

- FCA-7

₩IG-4

— CAT-11 -

SEE L2,15

RIVER ROCK, TYP.

GMC-3

MCS-6

SED-10

- 5. REFER TO L1.00 SERIES SHEETS FOR TREE PLANTINGS.
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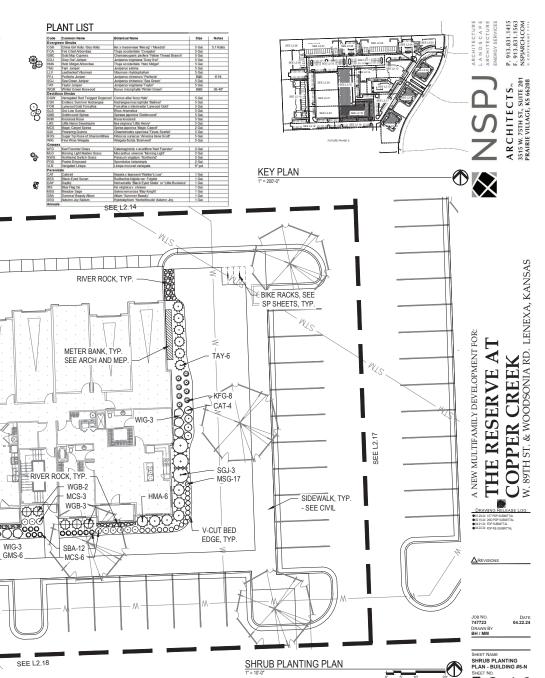
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BUILDING #5-N


KNR-2


FCA-3

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FINAL DEVELOPMENT PLAN



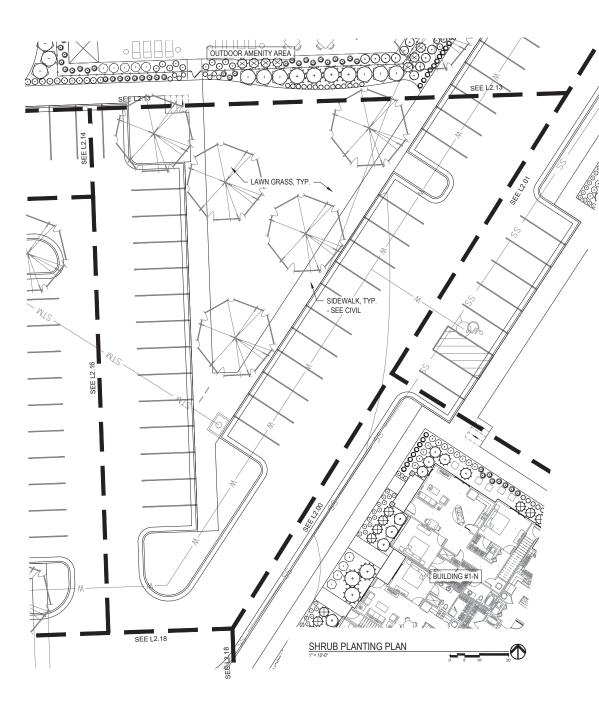

## PLANT LIST

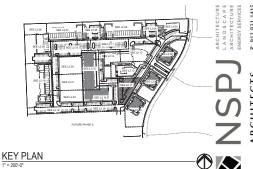Code	Common Name	Botanical Name	Size	Notes
Everg	een Shrubs			
CGH	China Girl Holly / Boy Holly	llex x meserveae 'Mesog' / 'Mesdob'	5 Gal.	5:1 Ratio
FCA	Fire Chief Arborytee	Thuja occidentalis 'Congabe'	5 Gal.	
GMC	Gold Mop Cypress	Chamaecyparis pisifera 'Yellow Thread Branch'	5 Gal.	
GOJ	Grey Owl Juniper	Juniperus virginiana 'Grey Owl'	5 Gal.	
HMA	Hetz Midget Arborvitae	Thuja occidentalis 'Hetz Midget'	5 Gal.	
TMJ	Tam Juniper	Juniperus sabina	5 Gal.	
LLV	Leatherleaf Vibumum	Vibumum rhytidophyllum	5 Gal.	
PFJ	Perfects Juniper	Juniperus chinensis 'Perfecta'	B&B	6'Ht.
SGJ	Sea Green Juniper	Juniperus chinensis 'Sea Green'	5 Gal.	
TAY	Taylor Juniper	Juniperus virginiana Taylor	5 Gal.	
WGB	Winter Green Boxwood	Buxus microphylle 'Winter Green'	B&B	36-48*
Decidi	ous Shrubs			
DGW	Variegated Red Twigged Dogwood	Comus alba 'Ivory Halo'	5 Gal.	
ESH	Endless Summer Hydrangea	Hydrangea macrophyla 'Balmer'	5 Gal.	
FOR	Lynwood Gold Forsythia	Forsythia x intermedia "Lynwood Gold"	5 Gal.	
GLS	Gro-Low Sumac	Rhus Aromatica	5 Gal.	
GMS	Goldmound Spirea	Spiraea japonica 'Goldmound'	5 Gal.	
KNR	Knockout Rose	Rosa knockout	5 Gal.	
LHS	Little Henry Sweets pire	tea virginica 'Little Henry'	5 Gal.	
MCS	Magic Carpet Spirea	Spirea japonica 'Magic Carpet'	2 Gal.	
QUI	Flowering Quince	Chaenomeles speciosa Texas Scarlet	5 Gal.	
ROS	Sugar Tip Rose of Sharon/Athea	Hibiscus syriacus 'America Irene Scott'	5 Gal.	
WIG	Fine Wine Weigela	Weigela forida 'Bramwell'	5 Gal.	
Grasse	6			
KEG	Karl Foerster Grass	Calamagrostis x acutifora 'Karl Foerster'	2 Gal.	
MLG	Moming Light Maiden Grass	Miscenthus sinensis 'Morning Light'	2 Gal.	
NWG	Northwind Switch Grass	Panicum virgatum 'Northwind'	2 Gal.	
PDS	Prairie Dropseed	Sporobolus heterolepis	2 Gal.	
VLR	Varioated Lirippe	Liricoe muscari variegata	6" pot	
Perent	ials			
CAT	Cetmint	Nepeta x faasseni 'Walker's Low'	1 Gal.	
BES	Black-Eved Susan	Rudbeckia fulgida var. Fulgida	1 Gal.	
DAY	Daylily	Hemercallis 'Black Eyed Stella' or 'Little Business'	1 Gal.	
RS	Blue Fleg Iris	Iris virginice v. shrevei	1 Gal.	
MSG	Meadow Sage	Salvia nemorosa 'May Knight'	1 Gal.	
SBA	Summer Beauty Allium	Alium 'Summer Beauty'	1 Gal.	
SED	Autumn Joy Sedum	Hyfotelephium 'Herbstfreude' Autumn Joy	1 Gal.	

### GENERAL NOTES:

- EACH BIDDER SHALL VISIT THE SITE OF THE PROPOSED WORK AND EXAMINE THE SITE
  CONTINUES. HE SHALL ALSO CAREFULLY EXAMINE THE DRAWINGS FOR THE PROPOSED WORK
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   A. CREEPING GROUNDCOVER SHALL BE A MINIMUM OF FROM PAVING EDGE.

   B. ALL TREES SHALL BE A MINIMUM OF 3 FROM PAVING EDGE.

   C. ALL PLANTS OF THE SAME SPECIES SHALL BE EQUALLY SPACED APART AND PLACED FOR BEST ASSITED TO WHICH SHALL S

  - D. ALL SHRUBS SHALL BE A MINIMUM OF 2' FROM PAVED EDGE.
- 3. NOTIFY LANDSCAPE ARCHITECT I WEEK PRIOR TO ANTICIPATED START OF PLANT MATERIAL INSTALLATION. LANDSCAPE CONTRACTOR SHALL STAKE ALL PROPOSED PLANTING BED EDGES. SET OUT SHRUBS IN INTERNEE LOCATIONS, AND STAKE TREE LOCATIONS FOR APPROVAL BY LANDSCAPE ARCHITECT PRIOR TO INSTALLATION.
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- FINISHED GRADE TO BE TOP OF MULCH OR TURF FOR ALL LANDSCAPE AREAS. REFER TO CIVIL PLANS FOR GRADING INFORMATION.
- 13. ALL LANDSCAPE AREAS NOT IDENTIFIED WITH MULCH, RIVER ROCK, OR OTHER PLANT MATERIAL TO BE SOD. SOD TO EXTEND TO BACK OF CURB FOR ADJACENT PUBLIC STREET.
- 14. STEPPING STONES SHALL BE HICKORY GREY FLAGSTONE AS PROVIDED BY SEMCO MATERIALS OR APPROVED EQUAL. 24" SQ. MIN. SIZE, 2-3" THICK.

JOB NO. 747723 DATE 04.22.24 BH / MM

SHEET NAME
SHRUB PLANTING PLAN
- PARKING AREA

FINAL DEVELOPMENT PLAN L2.17

OPPER CREEK
89TH ST. & WOODSONIA RD. LENEXA, KANSAS

MULTIFAMILY DEVELOPMENT FOR: THE RESERVE AT


- EACH BIDDER SHALL VISIT THE SITE OF THE PROPOSED WORK AND EXAMINE THE SITE CONDITIONS. HE SHALL ALSO CAREFULLY EXAMINE THE DRAWINGS FOR THE PROPOSED WORK AND FAMILIARIZE HIMSELF WITH ALL CONDITIONS, WHICH MAY AFFECT THE PROPOSED WORK.
- THE PLANTING PLAN GRAPHICALLY ILLUSTRATES OVERALL PLANT MASSINGS. EACH PLANT SPECIES MASSING SHALL BE PLACED IN THE FIELD TO UTILIZE GREATEST COVERAGE OF GRAPHICAL PLANT OF THE SHALL BE A MINIMUM OF FIRM AN AVING EDGE.


  A CHEEPING GROUNDCOVER SHALL BE A MINIMUM OF FIRM SHOW SHING EDGE.
  C. ALI PLANTS OF THE SAME SPECIES SHALL BE COULTLY SPACED APART AND PLACED FOR BEST ASSTHERD VIEWING.
  D. ALL SHRUSS SHALL BE A MINIMUM OF 2' FROM PAVED EDGE.


- NOTIFY LANDSCAPE ARCHITECT 1 WEEK PRIOR TO ANTICIPATED START OF PLANT MATERIAL INSTALLATION. LANDSCAPE CONTRACTOR SHALL STAKE ALL PROPOSED PLANTING BED EDGES, SET OUT SHRIBES IN INTENDED LOCATIONS, AND STAKE TREE LOCATIONS FOR APPROVAL BY LANDSCAPE ARCHITECT PRIOR TO INSTALLATION.
- 4. ALL NEW PLANT BED AREAS TO BE IRRIGATED. REFER TO SPECIFICATIONS FOR IRRIGATION SYSTEM DESCRIPTION.
- 5. REFER TO L1.00 SERIES SHEETS FOR TREE PLANTINGS.
- 6. REFER TO L2.00 SERIES SHEETS FOR SHRUB PLANTINGS & ROCK MATERIALS.
- 7. REFER TO L3.00 SERIES SHEETS FOR PLANTING DETAILS & SPECIFICATIONS.

- 8. IN THE EVENT OF WORK IN OR ON THE JCW SANITARY MAIN. ANY TREES OR PLANTINGS PLACED WITHIN THE SEWER EASEMENT MAY BE REMOVED WITHOUT REPLACEMENT OR COMPENSATION THERE OF AND SHALL BE REPLACED BY THE PROPERTY OWNER AS REQUIRED BY THE CITY.
- STRIP TOP SOIL & SAVE FOR PLANTING AREAS. EXCAVATE TO A DEPTH OF 6° FOR ALL
  PLANTING SEDS AND AMEND WITH PLANTING SOIL MIX. AREAS WITH MORE THAN 16° OF
  GRAVEL IN PLANT BEDS SHALL BE EXCAVATED 10 16° OR 6° BELOW ROOT BALLS/BOTTOM OF
  CONTAINER, REFER TO L3.00 FOR PLANTING SOIL MIX.
- 10. ROCK BEDS SHALL BE BUFFALO RIVER ROCK, 1"-2.5" SIZE, BY HOUSE OF ROCKS OR APPROVED EQUAL. ALL ROCK BED AREAS SHALL HAVE FILTER FABRIC & BE 4" MIN. DEPTH.
- 11. ALL LANDSCAPE BEDS WITHIN POOL ENCLOSURE TO INCLUDE RIVER ROCK PER SPECS.
- 12. FINISHED GRADE TO BE TOP OF MULCH OR TURF FOR ALL LANDSCAPE AREAS. REFER TO CIVIL PLANS FOR GRADING INFORMATION
- ALL LANDSCAPE AREAS NOT IDENTIFIED WITH MULCH, RIVER ROCK, OR OTHER PLANT MATERIAL TO BE SOD. SOD TO EXTEND TO BACK OF CURB FOR ADJACENT PUBLIC STREET.
- 14. STEPPING STONES SHALL BE HICKORY GREY FLAGSTONE AS PROVIDED BY SEMCO MATERIALS OR APPROVED EQUAL. 24" SQ. MIN. SIZE, 2-3" THICK.

Code	Common Name	Botanical Name	Size	Notes
Evergr	een Shrubs			
CGH	China Girl Holly / Boy Holly	lex x meserveae 'Mesog' / 'Mesdob'	5 Gal.	5:1 Ratio
FCA	Fire Chief Arborytae	Thuja occidentalis 'Congabe'	5 Gal.	
GMC	Gold Mop Cypress	Chamaecyparis pisifera "Yellow Thread Branch"	5 Gal.	
GOJ	Grey Owl Juniper	Juniperus virginiana 'Grey Owl'	5 Gal.	
HMA	Hetz Midget Arborvitae	Thuja occidentalis "Hetz Midget"	5 Gal.	
TMJ	Tam Juniper	Juniperus sabina	5 Gal.	
LLV	Leatherleaf Viburnum	Viburnum rhytidophyllum	5 Gal.	
PFJ	Perfects Juniper	Juniperus chinens is 'Perfecta'	B&B	6" Ht.
SGJ	Sea Green Juniper	Juniperus chinens is 'Sea Green'	5 Gal.	
TAY	Taylor Juniper	Juniperus virginiana 'Taylor'	5 Gal.	
WGB	Winter Green Boxwood	Buxus microphylle 'Winter Green'	B&B	36-48*
Decidio	ous Shrubs			
DGW	Variegated Red Twigged Dogwood	Comus alba 'vory Halo'	5 Gal.	
ESH	Endless Summer Hydrangea	Hydrangea macrophylia 'Bailmer'	5 Gal.	_
FOR	Lynwood Gold Forsythia	Fors White x informedia "Lynwood Gold"	5 Gal.	
GLS	Gro-Low Sumac	Rhus Aromatica	5 Gal.	
GMS	Goldmound Spirea	Spiraea japonica 'Goldmound'	5 Gal.	
KNR	Knockout Rose	Rosa knockout	5 Gal.	
LHS	Little Henry Sweetspire	tea virginica 'Little Henry'	5 Gal.	
MCS	Magic Carpet Spirea	Spirea japonica 'Magic Carpet'	2 Gal.	
QUI	Flowering Quince	Chaenomeles speciosa 'Texas Scarlet'	5 Gal.	
ROS	Sugar Tip Rose of Sharon/Affrea	Hibiscus swiacus 'America Irene Scoti'	5 Gal.	
WIG	Fine Wine Weigela	Weigela florida 'Bramwell'	5 Gal.	_
Grasse	4			
KFG	Karl Foerster Grass	Calamacrostis x acutiflora 'Karl Foerster'	2 Gal.	
MIG	Moming Light Maiden Grass	Miscenthus sinensis "Morning Light"	2 Gal	_
NWG	Northwind Switch Grass	Penicum virgetum Northwind	2 Gal.	
PDS	Prairie Dropseed	Sporobolus heterolepis	2 Gal.	
VLR	Varigated Lirippe	Liriope muscari variegata	6" pot	
Perent	ials			
CAT	Catmint	Nepeta x faassenii 'Walker's Low'	1 Gal.	_
BES	Black-Eved Susan	Rudbeckia fulgida var. Fulgida	1 Gal.	_
DAY	Davily	Hemercallis 'Black Eved Stella' or 'Little Business'	1 Gal.	
RS	Blue Fleg Iris	Iris virginica v. shrevei	1 Gal	_
MSG	Meadow Sage	Salvia nemorosa "May Knight"	1 Gal.	_
SBA	Summer Beauty Allium	Alium 'Summer Beauty'	1 Gal	

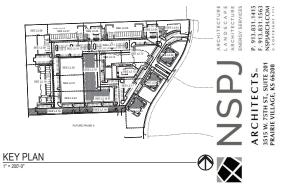

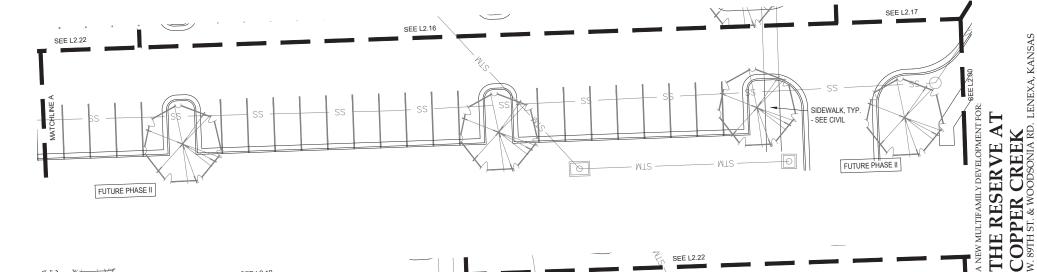

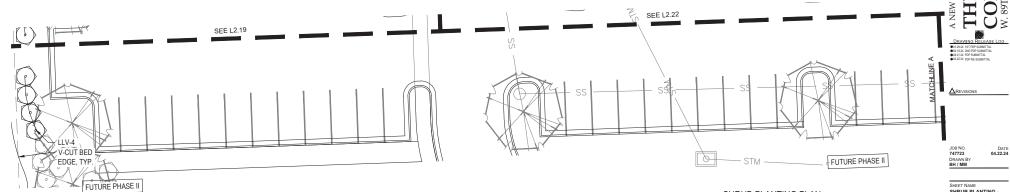

SHRUB PLANTING PLAN

SHEET NAME
SHRUB PLANTING PARKING AREA
SHEET NO.

L2.18 FINAL DEVELOPMENT PLAN

- EACH BIDDER SHALL VISIT THE SITE OF THE PROPOSED WORK AND EXAMINE THE SITE CONDITIONS. HE SHALL ALSO CAREFULLY EXAMINE THE DRAWINGS FOR THE PROPOSED WORK AND FAMILIARIZE HIMSELF WITH ALL CONDITIONS, WHICH MAY AFFECT THE PROPOSED WORK.
- 2. THE PLANTING PLAN GRAPHICALLY ILLUSTRATES OVERALL PLANT MASSINGS. EACH PLANT SPECIES MASSING SHALL BE PLACED IN THE FIELD TO UTILIZE GREATEST COVERAGE OF OWNER OF THE PLANT OF THE PLANT OF THE ADMINIST EDGE.

  A. CREEPING GROUNDCOVER SHALL BE A MINIMUM OF FFROM PAVING EDGE.

  C. ALL PLANTS OF THE SAME SPECIES SHALL BE COULD'S PAPACED APART AND PLACED FOR BEST ASSINETIO WIEWING.


  D. ALL SPRINGS SHALL BE A MINIMUM OF 2 FROM PAVED EDGE.


- NOTIFY LANDSCAPE ARCHITECT 1 WEEK PRIOR TO ANTICIPATED START OF PLANT MATERIAL INSTALLATION. LANDSCAPE CONTRACTOR SHALL STAKE ALL PROPOSED PLANTING BED EDGES SET OUT SHRIBES IN METNEDE LOCATIONS, AND STAKE TREE LOCATIONS FOR APPROVAL BY LANDSCAPE ARCHITECT PRIOR TO INSTALLATION.
- 4. ALL NEW PLANT BED AREAS TO BE IRRIGATED. REFER TO SPECIFICATIONS FOR IRRIGATION SYSTEM DESCRIPTION.
- 5. REFER TO L1.00 SERIES SHEETS FOR TREE PLANTINGS.
- 6. REFER TO L2.00 SERIES SHEETS FOR SHRUB PLANTINGS & ROCK MATERIALS.
- 7. REFER TO L3.00 SERIES SHEETS FOR PLANTING DETAILS & SPECIFICATIONS

- 8. IN THE EVENT OF WORK IN OR ON THE JCW SANITARY MAIN. ANY TREES OR PLANTINGS PLACED WITHIN THE SEWER EASEMENT MAY BE REMOVED WITHOUT REPLACEMENT OR COMPENSATION THERE OF AND SHALL BE REPLACED BY THE PROPERTY OWNER AS REQUIRED BY THE CITY.
- STRIP TOP SOIL & SAVE FOR PLANTING AREAS. EXCAVATE TO A DEPTH OF 6" FOR ALL PLANTING BEDS AND AMEND WITH PLANTING SOIL MIX. AREAS WITH MORE THAN 18" OF GRAVEL IN PLANT BEDS SHALL BE EXCAVATED 10 18" OR 8" BELOW ROOT BALLS/BOTTOM OF CONTAINER, REFER TO L3.00 FOR PLANTING SOIL MIX.
- 10. ROCK BEDS SHALL BE BUFFALO RIVER ROCK, 1\*-2.5" SIZE, BY HOUSE OF ROCKS OR APPROVED EQUAL. ALL ROCK BED AREAS SHALL HAVE FILTER FABRIC & BE 4" MIN. DEPTH.
- 11. ALL LANDSCAPE BEDS WITHIN POOL ENCLOSURE TO INCLUDE RIVER ROCK PER SPECS.
- 13. ALL LANDSCAPE AREAS NOT IDENTIFIED WITH MULCH, RIVER ROCK, OR OTHER PLANT MATERIAL TO BE SOD. SOD TO EXTEND TO BACK OF CURB FOR ADJACENT PUBLIC STREET.

14. STEPPING STONES SHALL BE HICKORY GREY FLAGSTONE AS PROVIDED BY SEMCO MATERIALS OR APPROVED EQUAL. 24" SQ. MIN. SIZE, 2-3" THICK.



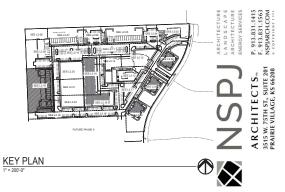

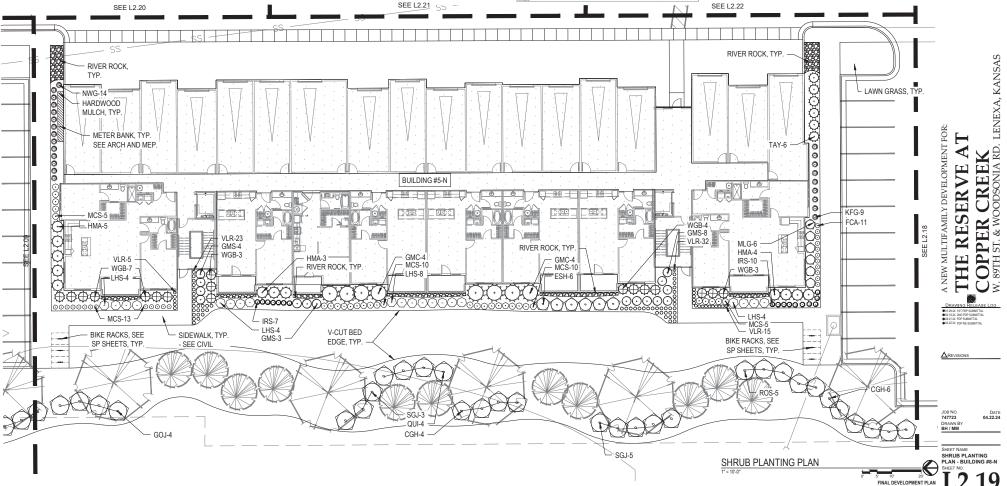

- EACH BIDDER SHALL VISIT THE SITE OF THE PROPOSED WORK AND EXAMINE THE SITE CONDITIONS. HE SHALL ALSO CAREFULLY EXAMINE THE DRAWINGS FOR THE PROPOSED WORK AND FAMILIARIZE HIMSELF WITH ALL CONDITIONS, WHICH MAY AFFECT THE PROPOSED WORK.
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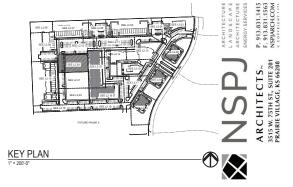
  A LITREES SHALL BE A MINIMUM OF 5' FROM PAVING EDGE.
  C. ALI PLANTS OF THE SAME SPECIES SHALL BE COULT. YE PAPACED APART AND PLACED FOR BEST ASSTHETING VIEWING.
  D. ALL SPRINGS SHALL BE A MINIMUM OF 2' FROM PAVED EDGE.


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- 8. IN THE EVENT OF WORK IN OR ON THE LCW SANITARY MAIN. ANY TREES OR PLANTINGS PLACED WITHIN THE SEWER EASEMENT MAY BE REMOVED WITHOUT REPLACEMENT OR COMPENSATION THERE OF AND SHALL BE REPLACED BY THE PROPERTY OWNER AS REQUIRED.
- STRIP TOP SOIL & SAVE FOR PLANTING AREAS. EXCAVATE TO A DEPTH OF 6" FOR ALL PLANTING BEDS AND AMEND WITH PLANTING SOIL MIX. AREAS WITH MORE THAN 16" OF GRAVEL IN PLANT BEDS SHALL BE EXCAVATED TO 16" OR 8" BELOW ROOT BALLS/BOTTOM OF CONTAINER, REFER TO 12.30" FOR PLANTING SOIL MIX.
- 10. ROCK BEDS SHALL BE BUFFALO RIVER ROCK, 1\*-2.5" SIZE, BY HOUSE OF ROCKS OR APPROVED EQUAL. ALL ROCK BED AREAS SHALL HAVE FILTER FABRIC & BE 4" MIN. DEPTH.
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Code	Common Name	Botanical Name	Size	Notes
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CGH	China Girl Holly / Boy Holly	lex x meserveae 'Mesog' / 'Mesdob'	5 Gal.	5:1 Ratio
FCA	Fire Chief Arborytee	Thuia occidentalis 'Congabe'	5 Gal.	
GMC	Gold Mop Cypress	Chamaecyparis pisifera 'Yellow Thread Branch'	5 Gal.	
GOJ	Grey Owl Juniper	Juniperus virginiana 'Grey Owl'	5 Gal.	
HMA	Hetz Midget Arborvitae	Thuja occidentalis "Hetz Midget"	5 Gal.	
TMJ	Tam Juniper	Juniperus sabina	5 Gal.	
LLV	Leatherleaf Viburnum	Viburnum rhytidophyllum	5 Gal.	
PFJ	Perfects Juniper	Juniperus chinens is 'Perfecta'	B&B	6 Ht.
SGJ	Sea Green Juniper	Juniperus chinens is 'Sea Green'	5 Gal.	
TAY	Taylor Juniper	Juniperus virginiana 'Taylor'	5 Gal.	
WGB	Winter Green Boxwood	Buxus microphylla 'Winter Green'	B&B	36-48*
	ous Shrubs			
DGW	Variegated Red Twigged Dogwood	Comus alba 'wory Halo'	5 Gal.	
ESH	Endless Summer Hydrangea	Hydrangea macrophylia 'Bailmer'	5 Gal.	
FOR	Lynwood Gold Forsythia	Fors ythia x intermedia "Lynwood Gold"	5 Gal.	
GLS	Gro-Low Sumac	Rhus Aromatica	5 Gal.	
GMS	Goldmound Spirea	Spiraea japonica 'Goldmound'	5 Gal.	
KNR	Knockout Rose	Rosa knockout	5 Gal.	
LHS	Little Henry Sweetspire	tea virginica 'Little Henry'	5 Gal.	
MCS	Magic Carpet Spirea	Spirea japonica 'Magic Carpel'	2 Gal.	
QUI	Flowering Quince	Chaenomeles speciosa 'Texas Scarlet'	5 Gal.	
ROS	Sugar Tip Rose of Sharon/Affrea	Hibiscus syriacus 'America Irene Scoti'	5 Gal.	
WIG	Fine Wine Weigela	Weigela fiorida 'Bramwell'	5 Gal.	
Grasse	6			
KFG	Karl Foerster Grass	Calamagrostis x acutiflora 'Karl Foerster'	2 Gal.	
MLG	Morning Light Maiden Grass	Miscenthus sinensis "Morning Light"	2 Gal.	
NWG	Northwind Switch Grass	Panicum virgatum 'Northwind'	2 Gal.	
PDS	Prairie Dropseed	Sporobolus heterolepis	2 Gal.	
VLR	Varigated Liriope	Liriope muscari variegata	6" pot	
Perent	ials			
CAT	Catmint	Nepeta x faassenii 'Walker's Low'	1 Gal.	
BES	Black-Eved Susan	Rudbeckia fulgida var. Fulgida	1 Gal.	
DAY	Dayliy	Hemercallis 'Black Eyed Stella' or 'Little Business'	1 Gal.	
RS	Blue Flag Iris	Iris virginica v. shrevei	1 Gal.	
MSG	Meadow Sage	Salvia nemorosa 'May Knight'	1 Gal.	
SBA	Summer Beauty Allium	Alium 'Summer Beauty'	1 Gal.	
SED	Autumn Joy Sedum	Hylotelephium 'Herbstfreude' Autumn Joy	1 Gal.	

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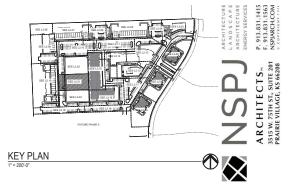
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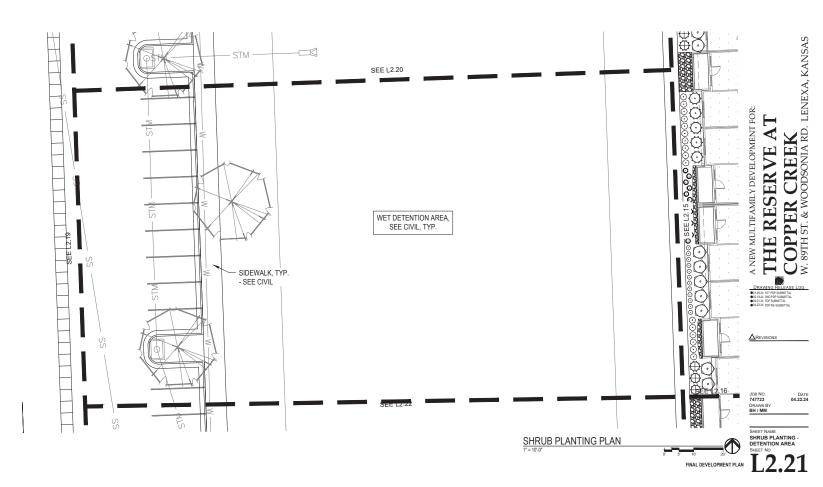
  A LITREES SHALL BE A MINIMUM OF 5' FROM PAVING EDGE.
  C. ALI PLANTS OF THE SAME SPECIES SHALL BE COULT. YE PAPACED APART AND PLACED FOR BEST ASSTHETING VIEWING.
  D. ALL SPRINGS SHALL BE A MINIMUM OF 2' FROM PAVED EDGE.
- NOTIFY LANDSCAPE ARCHITECT 1 WEEK PRIOR TO ANTICIPATED START OF PLANT MATERIAL INSTALLATION. LANDSCAPE CONTRACTOR SHALL STAKE ALL PROPOSED PLANTING BED EDGES, SET OUT SHRIBES IN INTENDED LOCATIONS, AND STAKE TREE LOCATIONS FOR APPROVAL BY LANDSCAPE ARCHITECT PRIOR TO INSTALLATION.
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- 10. ROCK BEDS SHALL BE BUFFALO RIVER ROCK, 1"-2.5" SIZE, BY HOUSE OF ROCKS OR APPROVED EQUAL. ALL ROCK BED AREAS SHALL HAVE FILTER FABRIC & BE 4" MIN. DEPTH.
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GMS	Goldmound Spirea	Spiraea japonica 'Goldmound'	5 Gal.	-
KNR	Knockout Rose	Rosa knockout	5 Gal.	-
LHS	Little Henry Sweetspire	tea virginica 'Little Henry'	5 Gal.	-
MCS	Magic Carpet Spirea	Spirea japonica 'Magic Carpet'	2 Gal.	-
QUI	Flowering Quince	Chaenomeles speciosa 'Texas Scarlet'	5 Gal.	-
ROS	Sugar Tip Rose of Sharon/Athea	Hibiscus swiacus 'America Irene Scoti'	5 Gal.	-
WIG	Fine Wine Weigela	Weixela florida 'Bramwell'	5 Gal.	-
Grasse	16			
KFG	Karl Foerster Grass	Calamagrostis x acutiflora 'Karl Foerster'	2 Gal.	T
MLG	Morning Light Maiden Grass	Miscenthus sinensis "Morning Light"	2 Gal.	_
NWG	Northwind Switch Grass	Penicum virgetum 'Northwind'	2 Gal.	-
PDS	Prairie Dropseed	Sporobolus heterolepis	2 Gal.	-
VLR	Varigated Liricoe	Liricoe muscari variegata	6" pot	_
Perent	vials			
CAT	Cetroint	Nepeta x faassenii 'Walker's Low'	1 Gal.	
BES	Black-Eved Susan	Rudbeckia fulgida var. Fulgida	1 Gal.	-
DAY	Davliy	Hemercallis 'Black Eved Stella' or 'Little Business'	1 Gal.	_
RS	Blue Flag Iris	Iris virginica v. shrevei	1 Gal.	-
MSG	Meadow Sage	Salvia nemorosa 'May Knight'	1 Gal.	_
SBA	Summer Beauty Alium	Alium 'Summer Beauty'	1 Gal.	
SED	Autumn Joy Sedum	Hylotelephium 'Herbstfreude' Autumn Joy	1 Gal.	_

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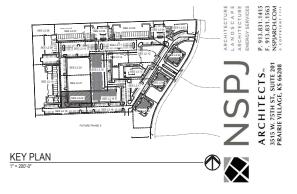
  A LITREES SHALL BE A MINIMUM OF 5' FROM PAVING EDGE.
  C. ALI PLANTS OF THE SAME SPECIES SHALL BE COULT. YE PAPACED APART AND PLACED FOR BEST ASSTHETING VIEWING.
  D. ALL SPRINGS SHALL BE A MINIMUM OF 2' FROM PAVED EDGE.


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- 7. REFER TO L3.00 SERIES SHEETS FOR PLANTING DETAILS & SPECIFICATIONS.

- 8. IN THE EVENT OF WORK IN OR ON THE JCW SANITARY MAIN. ANY TREES OR PLANTINGS PLACED WITHIN THE SEWER EASEMENT MAY BE REMOVED WITHOUT REPLACEMENT OR COMPENSATION THERE OF AND SHALL BE REPLACED BY THE PROPERTY OWNER AS REQUIRED BY THE CITY.
- 9. STRIP TOP SOIL & SAVE FOR PLANTING AREAS. EXCAVATE TO A DEPTH OF 6" FOR ALL 9. SINIP OF SOLE & SAVE FOR FLAVING SILEMI. ADVANTE TO ADDITION OF THAN 18" OF GRAVEL IN PLANT BEDS AND AMEND WITH PLANTING SOIL MIX. AREAS WITH MORE THAN 18" OF GRAVEL IN PLANT BEDS SHALL BE EXCAVATED TO 18" OR 8" BELOW ROOT BALLS/BOTTOM OF CONTAINER, REFER TO L3.00 FOR PLANTING SOIL MIX.
- 10. ROCK BEDS SHALL BE BUFFALO RIVER ROCK, 1"-2.5" SIZE, BY HOUSE OF ROCKS OR APPROVED EQUAL. ALL ROCK BED AREAS SHALL HAVE FILTER FABRIC & BE 4" MIN. DEPTH.
- 11. ALL LANDSCAPE BEDS WITHIN POOL ENCLOSURE TO INCLUDE RIVER ROCK PER SPECS.
- 12. FINISHED GRADE TO BE TOP OF MULCH OR TURF FOR ALL LANDSCAPE AREAS. REFER TO
- 13. ALL LANDSCAPE AREAS NOT IDENTIFIED WITH MULCH, RIVER ROCK, OR OTHER PLANT MATERIAL TO BE SOD. SOD TO EXTEND TO BACK OF CURB FOR ADJACENT PUBLIC STREET.
- 14. STEPPING STONES SHALL BE HICKORY GREY FLAGSTONE AS PROVIDED BY SEMCO MATERIALS OR APPROVED EQUAL. 24" SQ. MIN. SIZE, 2-3" THICK.

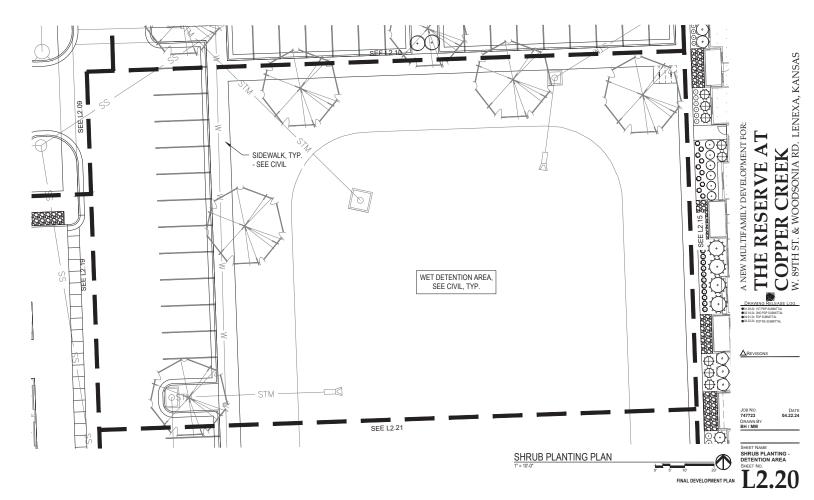Code	Common Name	Botanical Name	Size	Notes						
	een Shrubs									
CGH	China Girl Holly / Boy Holly	lex x meservege 'Mesog' / 'Mesdob'	5 Gal.	5:1 Rati						
FCA	Fire Chief Arborvitae	Thuja occidentalis 'Congabe'	5 Gal.							
GMC	Gold Mop Cypress	Chamaecyparis pisifera "Yellow Thread Branch"	5 Gal.							
BOJ	Grey Owl Juniper	Juniperus virginiana 'Grey Owl'	5 Gal.							
HMA	Hetz Midget Arborvitae	Thuja occidentalis "Hetz Midget"	5 Gal.							
TMJ	Tam Juniper	Juniperus sabina	5 Gal.							
LLV	Leatherleaf Viburnum	Viburnum rhytidophyllum	5 Gal.							
PFJ	Perfects Juniper	Juniperus chinens is 'Perfecta'	B&B	6" Ht.						
SGJ	Sea Green Juniper	Juniperus chinens is 'Sea Green'	5 Gal.							
TAY	Taylor Juniper	Juniperus virginiana 'Taylor'	5 Gal.							
WGB	Winter Green Boxwood	Buxus microphylla 'Winter Green'	B&B	36-48*						
Decidio	ous Shrubs									
DGW	Variegated Red Twigged Dogwood	Comus alba 'Vory Halo'	5 Gal.	_						
ESH	Endless Summer Hydrangea	Hydrangea macrophylia 'Bailmer'	5 Gal	_						
FOR	Lynwood Gold Forsythia	Fors Whia x informedia "Lyowood Gold"	5 Gal.							
GLS	Gm-Low Sumac	Rhus Aromatica	5 Gal							
GMS	Goldmound Spirea	Spiraea japonica 'Goldmound'	5 Gal.	_						
KNR	Knockout Rose	Rosa knockout	5 Gal.							
LHS	Little Henry Sweetspire	tea virginica 'Little Henry'	5 Gal.							
MCS	Magic Carpet Spirea	Spirea japonica 'Magic Carpet'	2 Gal.							
QUI	Flowering Quince	Chaenomeles speciosa 'Texas Scarlet'	5 Gal.							
ROS	Sugar Tip Rose of Sharon/Athea	Hibiscus syriacus 'America Irene Scott'	5 Gal							
WIG	Fine Wine Weigela	Weigela florida 'Bramwell'	5 Gal.	_						
Grasses										
KFG	Karl Foerster Grass	Calamagrostis x acutiflora 'Karl Foerster'	2 Gal.							
MIG	Morning Light Maiden Grass	Miscenthus sinensis 'Morning Light'	2 Gal.	_						
NWG	Northwind Switch Grass	Penicum virgetum Northwind	2 Gal.							
PDS	Prairie Dropseed	Sporobolus heterolepis	2 Gal.							
VLR	Varigated Liricoe	Liriope muscari variegata	6" pot							
Perent	vials									
CAT	Catmint	Nepeta x faassenii Walker's Low'	1 Gal.							
BES	Black-Eved Susan	Rudbeckia fulgida var. Fulgida	1 Gal.	-						
DAY	Davily	Hemercellis 'Black Eyed Stella' or 'Little Business'	1 Gal.							
RS	Blue Fleg Iris	Iris virginica v. shrevei	1 Gal.	-						
MSG	Meadow Sage	Salvia nemorosa 'May Knight'	1 Gal.	_						
SBA	Summer Beauty Allium	Alium 'Summer Beauty'	1 Gal	_						
SED	Autumn Joy Sedum	Hylotelephium 'Herbstfreude' Autumn Joy	1 Gal.	_						


DI ANTLICT



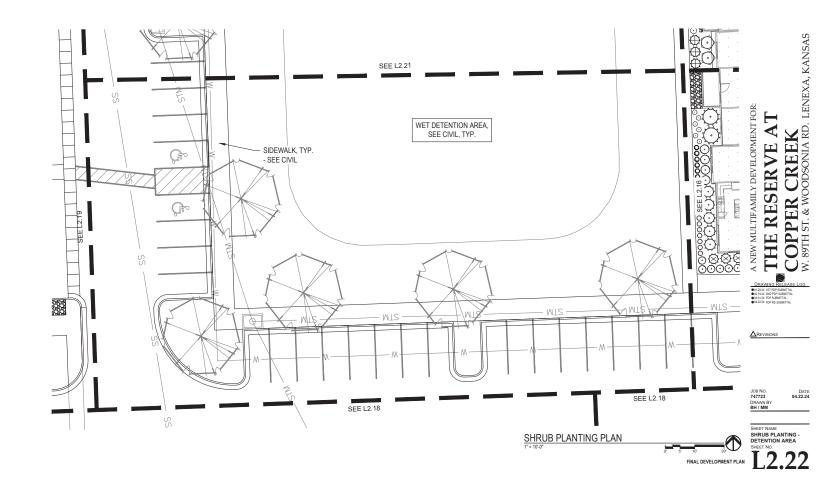

LUMINAIRE SCHEDULE												
PLAN			EQUIVALENT				LUMINAIRE S	BOURCE		ELECT	RICAL	
MARK	MANUFACTURER	MODEL	MANUF. SERIES	MOUNTING TYPE	FINISH	SOURCE TYPE	LUMENS	COLOR TEMP (K)	CRI	VOLTAGE	LOAD (VA)	DESCRIPTION
S1	LITHONIA	DSX1 LED P4 40K 80CRI T3M MVOLT PIR DBLXD		POLE	BLACK	LED	16272	4000	80	120		D-SERIES SIZE 1 LED LIGHT FOR SITE LIGHTING, MOUNT FIXTURE AT 25' ABOVE GRADE.
82	LITHONIA	DSX1 LED P4 40K 80CRI T3M MVOLT PIR HS DBLXD		POLE	BLACK	LED	16272	4000	80	120		D-SERIES SIZE 1 LED LIGHT FOR SITE LIGHTING WITH HOUSESIDE SHIELD. MOUNT FIXTURE AT 25' ABOVE GRADE.
83	LITHONIA	DSX1 LED P4 40K 80CRI T3M MVOLT		POLE	BLACK	LED	16272	4000	80	120		D-SERIES SIZE 1 LED LIGHT FOR SITE LIGHTING WITH 2 HEADS AT 180. MOUNT FIXTURES AT 25' ABOVE GRADE.

SUMMARY	
AVERAGE	2.1
MINIMUM	0.52
MAXIMUM	5.3
AVG/MIN RATIO	4.0
MAX/MIN RATIO	10

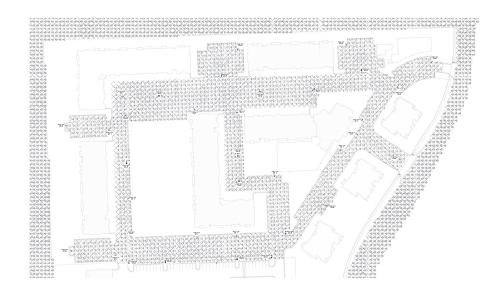

1 -Site Lighting Plan
E101) SCALE: 1" = 80'-0"



P. 913.831.1415 F. 913.831.1563 NSPJARCH.COM ARCHITECTS... 3515 W. 75TH ST., SUITE 201 PRAIRIE VILLAGE, KS 66208





COPPER CREEK
W. 89TH ST. & WOODSONIA RD. LENEXA, KS. THE RESERVE AT





USB NO. DATE
1747723 01.29.24
DRAWN BY
PM TORFY
SET DEFINITION
VOLUME #
SHEET NAME SITE LIGHTING PLAN
SHEET NO.
SHEET NO.









REAR ELEVATION
Scale: 1/8" = 1'-0"



FRONT ELEVATION - VIEW FROM WOODSONIA

Scale: 18" + 170" 2 LEFT ELEVATION
Scale: 1/8" = 1'-0"









## 3 NORTH ELEVATION Scale: 1/8" = 1'-0"



# 2 EAST ELEVATION Scale: 1/8" = 1"-0"




# SOUTH ELEVATION Scale: 1/8" = 1'-0"





## REAR ELEVATION Scale: 1/8" = 1"-0"

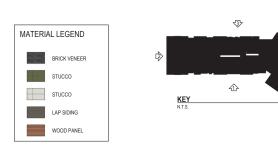



TOMES OF BIALDISC.

FRONT ELEVATION
Scale: 1/8" = 1'-0"



## BUILDING #4-N -RP-4 ZONING







REAR ELEVATION
Scale: 1/8' = 1'-0'



1) FRONT ELEVATION









RIGHT ELEVATION

Scale: 1/8" = 1'-0"




1 LEFT ELEVATION
Scale: 1/8" = 1'-0"





## 4 REAR ELEVATION Scale: 1/8" = 1'-0"

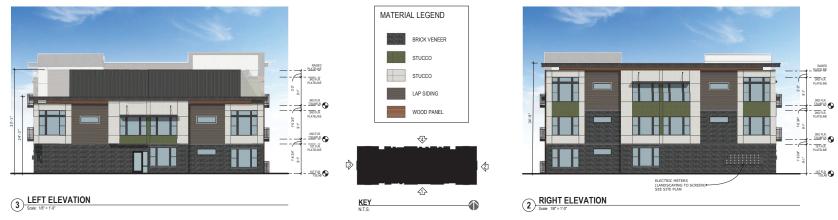



1 FRONT ELEVATION
Scale: 1/8" = 1'-0"



BUILDING #6-N -RP-4 ZONING







REAR ELEVATION
Scale: 1/8" = 1'-0"



FRONT ELEVATION
Scale: 1/8" = 1'-0"









RIGHT ELEVATION
Scale: 1/6" = 1'-0"



1 LEFT ELEVATION
Scale: 1/8" = 1'-0"




## REAR ELEVATION Scale: 1/8" = 1'-0"




1 FRONT ELEVATION




BUILDING #8-N -RP-5 ZONING

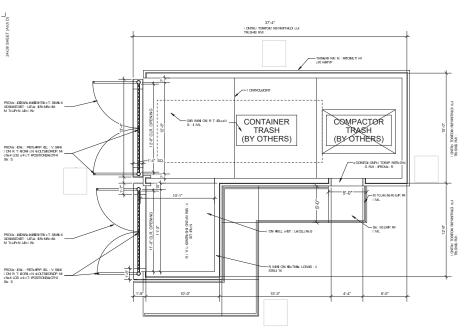



TRC SH4 N LOSUR: 48 LOOR4PLC N

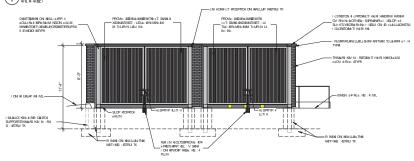


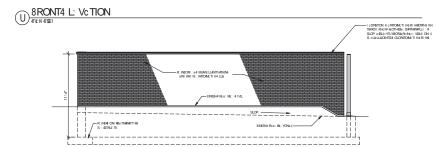

L: 8T4 L: Vc TION

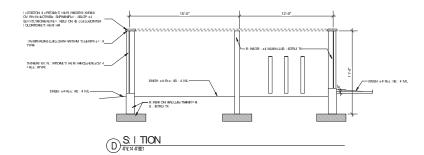

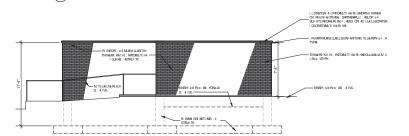

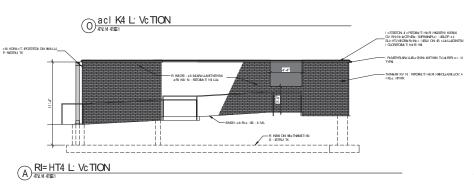

ARCHITECTS...
3515 W. 25TH ST, SUITE 201
PRAIRIE VILLAGE, KS 66208









OAK IQ - COPPER CREEK A NEW MULTIFAMILY DEVELOPMENT FOR: W. 89TH ST. & WOODSONIA RD. LENEXA, KANSAS

△REVISIONS

JOB NO. 747723 DRAWN BY BH / MM DATE 04.22.24

SHEET NAME TRASH ENCLOSURE

K1.05





May 6, 2024


## WATERCREST LANDING PRIVATE AMENITY

Project #: PL24-05FR Location: Southwest Corner of 89<sup>th</sup> Street and

Monticello Road

Applicant: Judd Claussen, Phelps Engineering Project Type: Revised Final Plan

Staff Planner: Dave Dalecky Proposed Use: Private subdivision amenity

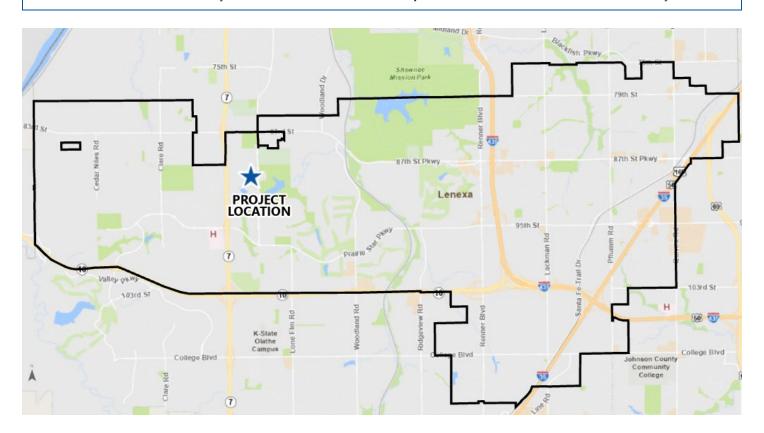

#### PROJECT SUMMARY

The applicant requests to revise the private amenity plan for the Watercrest Landing Subdivision. The revision is to remove a section of the private trail at the northwesterly part of the subdivision. The trail section is approximately 600 feet long and crosses a tract between the rear property lines of several lots. The trail was originally shown on the landscape plan submitted with the final plat for the Watercrest Landing subdivision (PT16-14F). The applicant states that a majority of the subdivision's residents support removing the trail from the amenity plan for the subdivision. A section of the trail has been installed in a tract on the easterly side of the subdivision.

The original amenity plan also showed a pool and cabana building on a tract in this subdivision. The pool has been relocated to a different phase of the subdivision and the tract has been replatted as a lot. This project does not require a Public Hearing.

STAFF RECOMMENDATION: APPROVAL



#### SITE INFORMATION

Watercrest Landing subdivision was rezoned and platted in 2016 (RZ16-04 & PL16-01P). The subdivision was initially intended to contain 120 lots. The developer acquired the land to the south of the original subdivision and expanded the subdivision. The Watercrest Landing subdivision is now approximately twice the size and will have 192 additional lots (RZ21-01 & PT21-02P). The expansion of the subdivision included relocating the pool amenity and other "active" features such as a sport court and playground to the south part of the development. Private trails in tracts of the original phase of the subdivision would remain as they were originally proposed.

LAND AREA (AC)

48

**BUILDING AREA (SF)** 

NA

**CURRENT ZONING** 

RP-1

COMP. PLAN
Low-Density Residential,
Suburban-Density
Residential, Medium
Density Residential, and

Office-Employment Center



Exhibit 1: Aerial image of Watercrest Landing subdivision (First and Second Plats are highlighted).



#### LAND USE REVIEW

Watercrest Landing subdivision is zoned RP-1, (RZ16-04 & RZ21-01). The original phase of the subdivision (first and second plats) is nearing completion. A few lots remain to be developed. The southerly part of the subdivision has several homes built or under construction but is still in the early stages of construction. Streets and infrastructure are still being constructed in this phase.



TABLE 1: COMPARISON OF SURROUNDING PROPERTIES				
Vicinity	Land Use Designation	Zoning	Current Use	
Subject Property	Low Density Residential, Suburban Density Residential, Medium Density Residential, & Office/Employment Center Public/Open Space	RP-1	Single-Family Residential	
North	Medium Density Residential	RP-2	Undeveloped	
South	Office/Employment Center & Open Space	RP-1. RP-4, & NP-O	Undeveloped land and City Park	
East	Low-Density Residential & Open Space	AG, & RE	Undeveloped	
West	Office/Employment Center	AG, RP-3, & NP-O	Undeveloped land and large residential estate parcel	



## **FINAL PLAN REVIEW**

The applicant is requesting final plan approval to revise the private trail amenity plan for the Watercrest Landing subdivision. The proposed revision is specifically for the first and second plats of the subdivision. The approved plan shows trails that are in private tracts of the subdivision. The trails are private, constructed by the developer, and are maintained by the HOA.

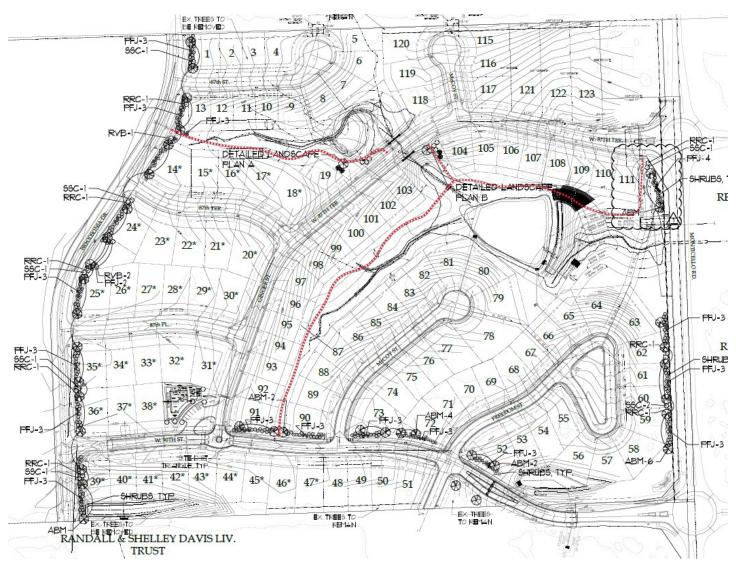


Exhibit 2: Original amenity plan showing the trails in a red dashed line.



In early 2024, changes were made to the Watercrest Landing HOA to install an Owner Board as part of the HOA, which is still controlled by the developer. A question and vote of lot owners was conducted in January of 2024 as follows:

We agree that the planned trail extension in Phase 1/2 of the development is not desired and further that it is acceptable that this remain undeveloped area. In exchange for our support with the City of Lenexa to revise the plan and remove the costs associated with this trail (estimated at \$70k), we further agree that the developer should deposit half of the savings from this change (\$35k) into the HOA fund at the time of handoff for the amenity center which is currently under construction so that much of the first year operating costs are covered.

Yes - 94% (74) No - 6% (5)

The Watercrest Landing HOA (of the first and second plats) has agreed with the developer to remove the westerly trail section from the private amenity package for the subdivision.

The revised plan also removes the pool and cabana from the first phase. The subdivision's pool amenity is currently under construction on a tract in Watercrest Landing, Third Plat, south of the first phase. A gazebo is now constructed in the island of the Freedom Street cul-de-sac at the southwesterly corner of the subdivision. The proposed amenity plan of the first phase will contain the trails as shown on the following exhibit:



Exhibit 3: Proposed Watercrest Landing Private Amenity Plan with northwest trail removed (First and Second Plats).

#### WATERCREST LANDING PRIVATE AMENITY - PL24-05FR





#### STORMWATER

No changes are made to the stormwater features of the subdivision.

#### LANDSCAPING

No changes are made to the landscaping for the subdivision.

#### **DEVIATIONS**

The applicant is not requesting any deviations.

#### **REVIEW PROCESS**


- The Planning Commission is the final authority for approval of this project.
- The applicant should inquire about additional City requirements, such as permits and development fees.

#### RECOMMENDATION FROM PROFESSIONAL STAFF


- ★ Staff recommends approval of the proposed Revised Final Plan for Watercrest Landing Private Amenity Plan.
  - The revised private amenity plan for Watercrest Landing (first and second plats) removes a section of the private trails within a tract owned by the HOA.
  - The project is consistent with Lenexa's goals through **Responsible Economic Development** to create **Vibrant Neighborhoods**.

#### **FINAL PLAN**

Staff recommends **approval** of the revised final plan for PL24-05FR – **Watercrest Landing Private Amenity** at the northwest corner of 89<sup>th</sup> Street and Monticello Road, for the private amenities of a single-family residential subdivision.

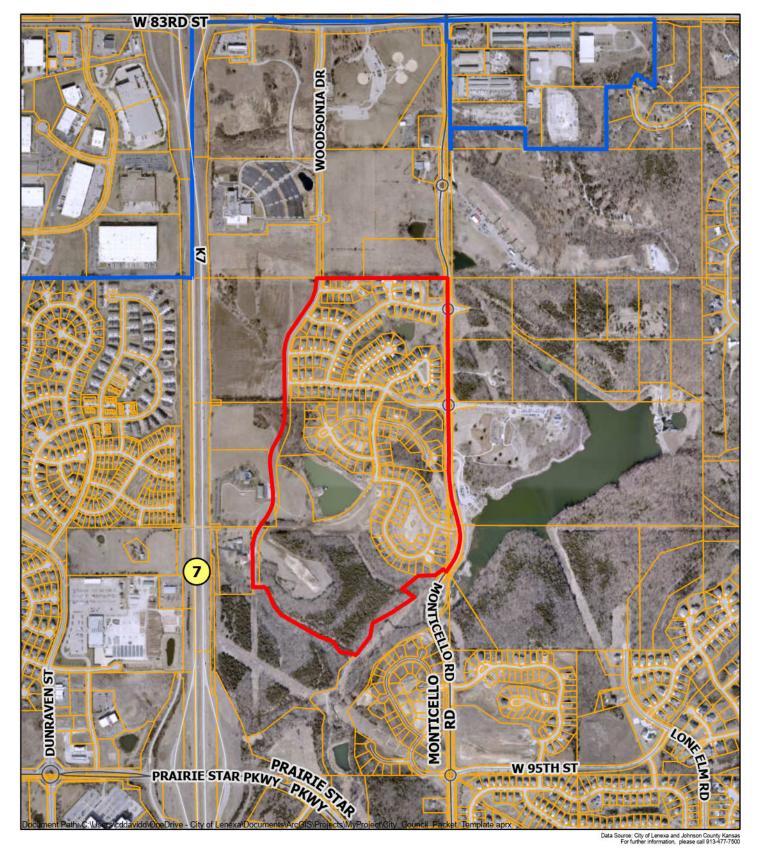

## **Watercrest Landing Private Amenity Plan**

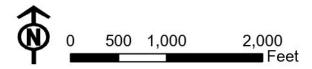





ARCHITECTURE
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ARCHITECTURE
IN T E R 10 R S
ENERGY SERVICES
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# WATERCREST LANDING NARRATIVE FOR CHANGES TO TRACT E WALKING TRAIL AND WATERCREST LANDING HOA GOVERNANCE

The WaterCrest Landing HOA annual meeting was held on December 13th, 2023. One of the topics discussed during the meeting was the walking trail that was planned for construction in Tract E of the subdivision.

There had been feedback from some residents that indicated some would prefer the trail not be constructed. A variety of reasons for the opposition to the trail being constructed were expressed:

- Close proximity to some homes backyards
- Loss of some vegetation to construct
- The western end of the trail would face Woodsonia and a future apartment complex and provide a gateway for non-residents to enter HOA property.

Since there was not 100% representation of all homeowners at the meeting there was a need to solicit feedback on the topic from a wider base of homeowners. As a follow up an email was sent on December 22, 2023 to all residents asking if they supported the construction of the trail or if they opposed. The initial response was split nearly 50-50 so the plan at the time was to proceed with construction.

However as part of the follow up discussions that were had with some homeowners a concept for making a change HOA governance emerged. Discussions were held by homeowners to gain consensus on changes to propose to the developer who also has control over the HOA. Those discussions resulted in a proposal and list of requests by the homeowners:

- 1. Owner run HOA Board composed of elected president, secretary and treasurer from the neighborhood, meeting quarterly with developer rep (Tom Bohanon is preferred)
- 2. Continue the services of MPMC to manage the HOA with clarity that owner to developer issues are managed by the above board and not MPMC
- 3. In exchange for resident support with city to revise plan eliminating path in Phase1/2, agreement that half of savings (\$35k) be invested in HOA by P&L on transfer of amenities center to HOA in order to cover increased costs

The developer agreed to all 3 requests and an election was held by the homeowners to elect the 3 persons to serve on the board along with the developer representative. As part of the same election homeowners voted on whether to construct the walking trail in Tract E as outlined in request 3. The vote was 94% to not build the trail. Voting results are attached here.



### Re: WaterCrest Landing HOA Voting Results

1 message

Michael Stephens <michael.stephens.home@gmail.com>

Sun, Feb 11, 2024 at 12:46 PM

To: Tom Bohanon <tomabohanon@gmail.com>, Annie Kennedy <akennedyrealestate@gmail.com>, Mickey <fivechiefs@aol.com>

Cc: David Brewer <a href="mailto:com">cc: David Brewer <a href="mailto

Hope you are all doing well and looking forward to a fun and exciting Super Bowl today. As you can see below, we have closed on the neighborhood voting and are ready to move forward.

We need one specific thing from you, Mickey:

• Please REPLY ALL and affirm that the new HOA board will consist of Michael Stephens, David Brewer, Jim Hampshire with Tom Bohanon as the developer representative

With that done, we'll meet together and then with MPMC to review contracts and coordinate with Tom on our first quarterly meeting where we will all formalize the new roles and approve the pending contracts for MPMC, Meers.

Please let us know how we can support you with the City of Lenexa as you propose the change to the Plan for Phase 1/2 to remove the trail. You can leverage the below and also share my contact information if they have questions. If you need one or more of us to attend or otherwise support, please let us know.

I want to thank you for putting us on a new footing together and I hope this is the start of something positive for our growing neighborhood.

- Michael michael.stephens.home@gmail.com

On Sun, Feb 11, 2024 at 12:32 PM Michael Stephens <michael.stephens.home@gmail.com> wrote:

Thank you all for taking the time to support our proposed changes to the WaterCrest Landing HOA. With the support of the developer, we proposed a change and you have overwhelmingly supported it. Below, you can find the detailed results for the vote.

Next up, we will request that the developer formally appoint the top three vote receivers to the HOA Board (that's the only legal way to do it under current declarations). The new board members will need to meet with MPMC to review their contract and the contract for Meers which are both due for renewal. We will also propose a schedule for the planned quarterly meetings with the developer which we intend to be open to all residents. The specific details of the board accountabilities vs. MPMC and the developer will be discussed and brought forward to provide clarity in the first of these quarterly meetings.

We would like to have the Watercrest Landing Home Owners Association Board run by elected representatives of the resident owners and would like for them to meet quarterly with a representative of the developer?

Yes - 100% (80)

We would like to have the Watercrest Landing Home Owners Association Board run by elected representatives of the resident owners and would like for them to meet quarterly with a representative of the developer?

Yes - 94% (74)

We agree that the planned trail extension in Phase 1/2 of the development is not desired and further that it is acceptable that this remain undeveloped area. In exchange for our support with the City of Lenexa to revise the plan and remove the costs associated with this trail (estimated at \$70k), we further agree that the developer should deposit half of the savings from this change (\$35k) into the HOA fund at the time of handoff for the amenity center which is currently under construction so that much of the first year operating costs are covered.

Yes - 94% (74)

No - 6% (5)

#### **Board Volunteers:**

David Brewer

Tom Barbee

Maria Barbee

Ann Colgan

Elizabeth DePriest

Paul Griesemer

Ann Hampshire

Jim Hampshire

David Komar

Kurt Miller

Michael Ricker

Michael Stephens

Ron Timbrook

Todd Wells

#### New WaterCrest Landing HOA Board:

- · Michael Stephens
- David Brewer
- · Jim Hampshire

#### PLANNING COMMISSION STAFF REPORT



May 6, 2024


## PRAIRIE VIEW AT CREEKSIDE WOODS SIXTH PLAT

Project #: PT24-03FR Location: Northwest Corner of Gander Street

and McCormack Drive

Applicant: Chip Corcoran, RIC Project Type: Final Plat

Staff Planner: Dave Dalecky Proposed Use: Single-Family Residential

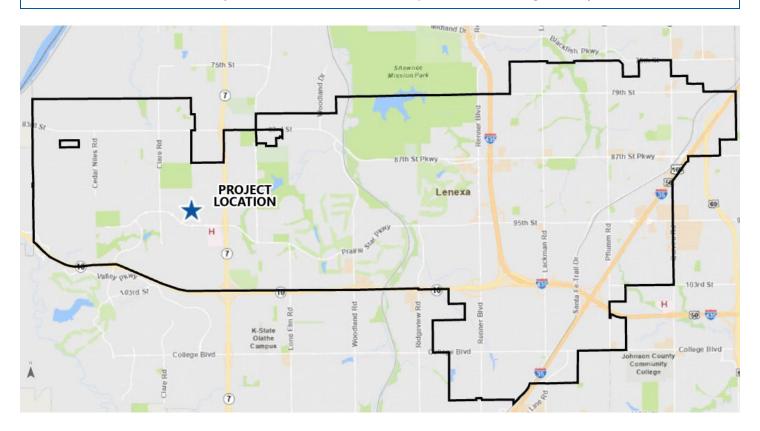

#### **PROJECT SUMMARY**

The applicant requests approval of a final plat to replat three undeveloped lots located in the Prairie View at Creekside Woods subdivision into two lots. The replat will allow the construction of two single-family residential dwellings. The three lots are uniquely shaped around the arc of a curved street and the proposed houses for the lots do not fit within the building envelope of the existing lots.

STAFF RECOMMENDATION: APPROVAL



#### SITE INFORMATION

The site is zoned RP-1, Planned Single-Family Residential District (RZ04-10). Prairieview at Creekside Woods subdivision began developing between 2008 and 2009. The subdivision is now nearing completion. The three lots to be replatted are Lots 115, 116, and 117. The three lots are a part of Prairie View at Creekside Woods Fourth Plat (PT20-03FR).

LAND AREA (AC) 0.68

CURRENT ZONING RP-1 COMP. PLAN
Suburban Residential



Exhibit 1: Aerial Image of Subject Site



## LAND USE REVIEW

The lots are within the Prairie View at Creekside Woods Fourth Plat. The use of the land is not changing from single-family residential development.



TABLE 1: COMPARISON OF SURROUNDING PROPERTIES				
Vicinity	Land Use Designation	Zoning	Current Use	
Subject Property	Suburban Residential	RP-1, Residential Planned Single-Family District	Undeveloped	
North	Suburban Residential	RP-1, Residential Planned Single-Family District	Single-Family	
South	Open Space	R-1, Single-Family Residential District	Public Safety Services (Lenexa Fire Station)	
East	Suburban Residential	RP-1, Residential Planned Single-Family District	Single-Family	
West	Suburban Residential Density and Neighborhood Retail	RP-1, Residential Planned Single-Family District; CP-1 and Planned Neighborhood Commercial District	Single-Family and Undeveloped	



#### **FINAL PLAT REVIEW**

The three existing lots front onto Gander Street around a curved section of the block. The developer is requesting to replat the three lots into two lots, increasing the size of the buildable space of the lots to accommodate specific house plans. The existing lots have a restrictive building envelope (the space on the lot where a building may be constructed) which will not accommodate the size of homes the prospective owner is requesting. Prairie View at Creekside Woods Fourth Plat was approved in late 2020 and recorded in late 2021. The plat contains 67 lots and three tracts. Two of the three lots to be replatted are 56 feet wide and slightly larger than 8,000 SF, which are the narrowest lots in the subdivision. These two lots would require a relatively narrow home to be constructed to meet the setback requirements and fit within the building envelope. The developer is requesting to replat the group of three lots into two lots so that new homes may be constructed on the lots that are consistent with the other homes constructed in the subdivision. The resulting lots are wider and provide a larger building envelope. The proposed lots are 12,514 SF and 17,005 SF. The replat complies with the Subdivision Regulations of Section 4-2 of the Unified Development Code.

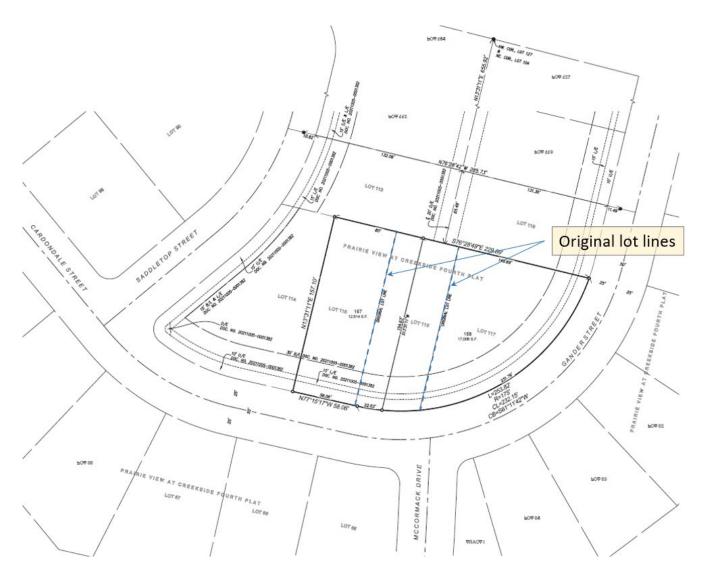


Exhibit 2: Excerpt of the proposed replat with lot details.



## **DEVIATIONS**

The applicant is not requesting any deviations from the Unified Development Code.

#### **REVIEW PROCESS**


• The Planning Commission is the final authority for approval of this project.

#### RECOMMENDATION FROM PROFESSIONAL STAFF


- ★ Staff recommends approval of the proposed Final Plat for Prairie View at Creekside Woods Sixth Plat.
  - This replat will change three lots into two lots to allow the development of two single-family homes.
  - The project is consistent with Lenexa's goals through **Sustainable Policies and Practices** to create **Vibrant Neighborhoods**.

#### FINAL PLAT

Staff recommends **APPROVAL** of the final plat for PT24-03FR – **Prairie View at Creekside Woods Sixth Plat**, located at the northwest corner of Gander Street and McCormack Drive, for a single-family residential use.

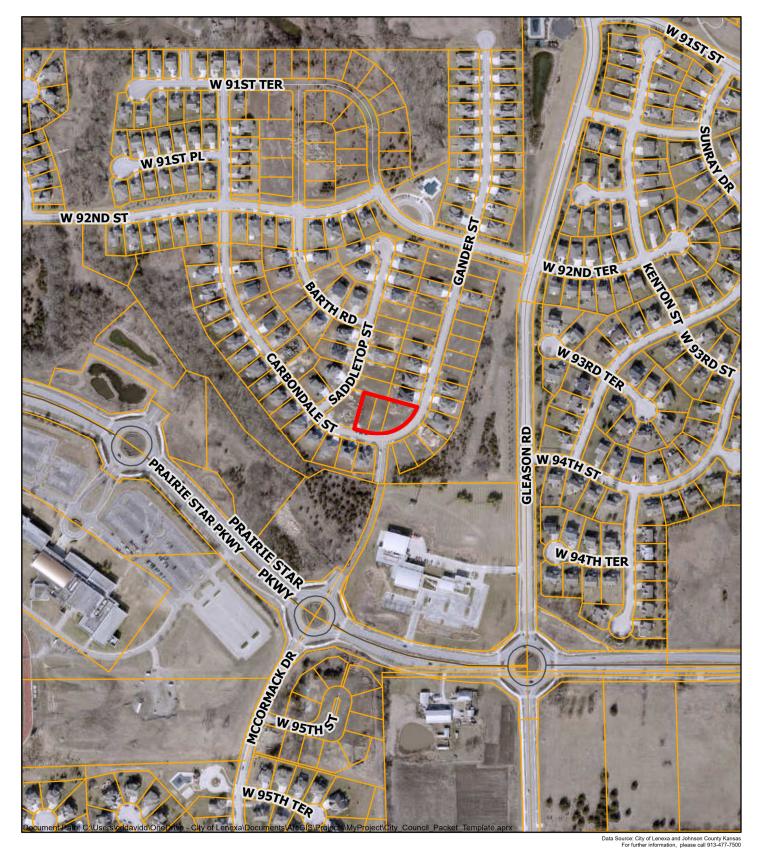


**Prairie View at Creekside Woods Sixth Plat** 

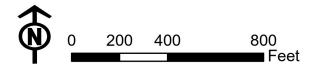



### PRAIRIE VIEW AT CREEKSIDE WOODS 6TH PLAT

A REPLAT OF LOTS 115-117, INCLUSIVE, PRAIRIE VIEW AT CREEKSIDE WOODS 4TH PLAT, A SUBDIVISION IN THE CITY OF LENEXA, JOHNSON COUNTY, KANSAS

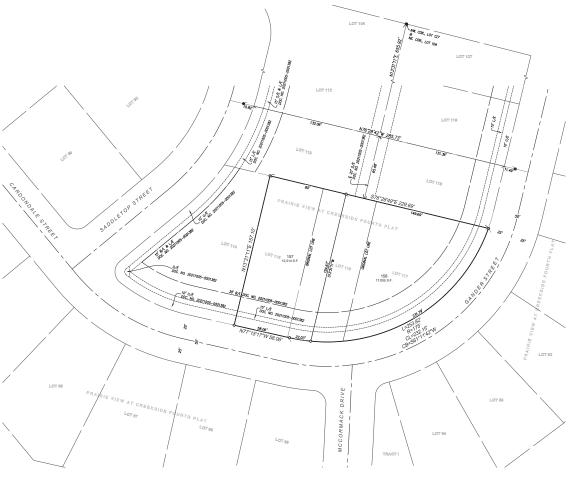

#### DESCRIPTION

A replat of all of Lots 115-117, inclusive, PRAIRIE VIEW AT CREEKSIDE WOODS 4TH PLAT, a subdivisions in the City of Lenexa, Johnson County, Kansas.

#### DEDICATION

#### "PRAIRIE VIEW AT CREEKSIDE WOODS 6TH PLAT"

An essement of license to enter upon, locate, constitut and maintain or suthrotize the location, constitution or maintenance and use of attents, custs, sidewalks, jogging traits, conduits, pipes, anisins, linkles, markoles, surface orinage foilistes, tiblies, landscaping and other imiliar facilities upon, over and under those areas outlined and designated on this plat as "Utility Essement" or "Utility was hereby granted for the City of License, Johnson County, Kansas, all book which was not to the control of the City of License, Johnson County, Kansas, all book when shown hereon, was hereby dedicated to the City of License, Johnson County, Kansas, at Book 2011, Page 1382, for its use and that of its designees or only authorized agents, for the purpose previously described. Ma based ground facilities associated with the used propose previously described. Was described and the control of the control of the Utility of the control of the control of the county of the control of the control of the control of the City Charles of the City Char

A 15-foot wide Landscape Easement or "L/E" was hereby reserved for the City of Lenexa, Johnson County, Kansas, at Book 202110, Page 1382, off of lots adjacent to and parallel with all Street Right-City(ay lines, when shown hereon. Maintenance of said easement shall be the responsibility of the homeowner and/or the Homeowners Association, with access granted to the

#### CONSENT TO LEVY

The undersigned proprietor of the above described tract of land hereby consents and agrees that the Board of County Commissioners of Johnson County, Karasas and the City of Lenexa.

If the County Commissioners of Johnson County, Karasas and the City of Lenexa.

Described to the County Cou

#### EXECUTION

IN TESTIMONY WHEREOF, the undersigned proprietor has caused this instrument to be

this \_\_\_\_\_day of \_\_\_\_\_\_ 20\_\_. Creekside Development LLC

Doug Claussen, Authorized Signe

STATE OF COUNTY OF \_\_\_\_\_

BE IT REMEMBERED, that on this day of 20\_, before me a Notary Public in and for said County and State, came Doug Clausen, Tille of Creekide Development LLC, who is personally known to me be bet same person who exceled the foregoing instrument of writing on behalf of said company, and he duly acknowledged the execution of the same bo be the act and deed of said company.

IN WITNESS WHEREOF, I have hereunto set my hand and seal on the day and year last writte

APPROVED by the Planning Commission of the City of Lenexa, Johnson County, Kansas, on this \_\_\_\_\_ day of \_

Chris Poss, Chairman

LOCATION MAP

NE 1/4

NW 1/4

#### LEGEND:

- 1. Basis of Bearings: PRAIRIE VIEW AT CREEKSIDE WOODS 4TH PLAT
- 2. Error of Closure: 1 part in: 1397324.00'

reby certify that during February, 2024, this field survey was completed on the ground by me or under my ct supervision, and that said survey meets or exceeds the current "Kansas Minimum Standards For Boundary veys" as established by the Kansas Board of Technical Professional.



#### PRAIRIE VIEW AT CREEKSIDE WOODS 4TH PLAT, REPLATED

age City, KS 66523

Date of Preparation: Revised: February 7, 2024 April 23, 2 April 23, 2024

Consulting

Renaissance nfrastructure

913.317.95



#### **CALL TO ORDER**

Chairman Poss called the regular meeting of the Lenexa Planning Commission to order at 7:00 p.m. on Monday, April 1, 2024. The meeting was held in the Community Forum at Lenexa City Hall at 17101 W. 87<sup>th</sup> Street Parkway, Lenexa, Kansas.

#### **ROLL CALL**

#### COMMISSIONERS PRESENT

Chairman Chris Poss
Vice-Chairman Mike Burson
Commissioner Don Horine
Commissioner David Woolf
Commissioner Curt Katterhenry
Commissioner Brenda Macke
Commissioner Cara Wagner

#### **COMMISSIONERS ABSENT**

Commissioner Ben Harber Commissioner John Handley

#### STAFF PRESENT

Scott McCullough, Director of Community Development Stephanie Kisler, Planning Manager Steven Shrout, Assistant City Attorney II

#### APPROVAL OF MINUTES

The minutes of the March 4, 2024 meeting were presented for approval. Chairman Poss entertained a motion to **APPROVE** the minutes. Moved by Commissioner Macke seconded by Commissioner Horine and **APPROVED** by a unanimous voice vote.

#### **CONSENT AGENDA**

- 1. Advent Health Building 2A and Parking Garage Consideration of a final plan for a medical office building and parking garage on the Advent Health Campus located at the southwest corner of 86th Street & Renner Boulevard within the CC, Planned City Center District. PL24-03F
- 2. Advent Health Building 2C Consideration of a final plan for a mixed-use building on the Advent Health Campus located at the northeast corner of westbound W. 87th Street & Scarborough Street within the CC, Planned City Center District. PL24-04F
- 3. Crown IV (Midwest Compounders) Consideration of a revised final plan for exterior modifications on property located at 13715 W. 109th Street within the CP-O, Planned General Office District, PL24-04FR



- 4. Westside Family Church, Second Plat Consideration of a revised final plat to construct an accessory office building on property located at 8500 Woodsonia Drive within the R-1, Single-Family Residential District. PT24-02FR
- 5. Spyridakis/Cooper Home Deviation Consideration of a deviation from the 25' side yard setback requirement to construct a single-family home at a 10' side yard setback on property located at 7802 Allman Road within the RP-E, Residential Planned Estate District. DV24-02

Chairman Poss entertained a motion to **APPROVE** Consent Agenda Items 1-5. Moved by Commissioner Horine seconded by Commissioner Katterhenry and carried by a unanimous voice vote.

#### REGULAR AGENDA

6. Request to Continue to the June 3, 2024 Planning Commission Meeting - Consideration of a preliminary plan for a mixed-use development on property located approximately at the southwest corner of 87th Street Parkway & Scarborough Street within the CC, Planned City Center District. PL24-02P.

#### **COMMISSION DISCUSSION**

Commissioner Horine asked the reason for the postponement. Stephanie Kisler responded by explaining that the application had been continued twice, primarily because Staff had been collaborating closely with the applicant to enhance the retail presence along the 87th Street segment of the project. She highlighted that the applicant was exploring the feasibility of incorporating additional intensity along 87th Street. Ms. Kisler noted that the current plans feature a parking garage fronting 87th Street, and Staff is working with the applicant to maximize activation through retail and office storefronts.

Henry Klover, Klover Architects, elaborated on their involvement in revising the plans, noting a unique approach required for the parking deck to span over the retail section. He mentioned the intricacies involving precast work and pricing, adding that completion of these tasks coincided with a period of vacation for everyone involved, thus pushing beyond this April 1st meeting. However, Mr. Klover expressed optimism, stating that despite increased construction costs, the project is progressing faster than anticipated. To ensure sufficient preparation time, they request extending the Planning Commission consideration to the June 3rd meeting.

Chairman Poss entertained a motion to continue City Center Area C Mixed-Use Hotel Development to the June 3, 2024 Planning Commission agenda. Moved by Commissioner Woolf seconded by Commissioner Wagner and carried by a unanimous voice vote.

#### STAFF REPORT

Scott McCullough informed the Commissioners that the Comprehensive Plan Open House took place last week, drawing approximately 55 participants. Mr. McCullough said the event lasted around two hours with consistent activity throughout. He then announced the upcoming Comprehensive Plan Work Session, which is a joint meeting scheduled with both the City Council and Planning Commission on April 23rd. He emphasized efforts to enhance the room setup to facilitate a more interactive session compared to previous joint meetings. Following the joint session, he mentioned that they will gather feedback and comments to finalize revisions to the



Comprehensive Plan. Subsequently, the formal adoption process will commence at the May 6th Planning Commission meeting. If approved, the plan will proceed for final adoption by the Governing Body on May 21st.

## **ADJOURNMENT**

Chairman Poss ended the regular meeting of the Lenexa Planning Commission at 7:10 p.m. on Monday, April 1, 2024.

